WAKELY ASSOCIATES, INC. ARCHITECTS 30500 Van Dyke Avenue Suite 209 Warren, MI 48093 ADDENDUM NO. 02
MACOMB COUNTY-COUNTY WAREHOUSE
F & O and PURCHASING OFFICES
Page 1 of 2 (write up only)

November 11, 2024

ADDENDUM NO. 02 to the plans and specifications for MACOMB COUNTY – COUNTY WAREHOUSE – F & O AND PURCHASING OFFICE RENOVATION, CLINTON TOWNSHIP, MI, Architect's Project No. 242053, dated OCTOBER 31, 2024

<u>Drawings G0,0, G2.0, G3.0, LS1.0, AD1.0, A1.0, A1.0A. A1.1, A1.2, A1.3, A2.0, A3.0, A4.0, A4.1 and A9.1 are being issued with this Addendum.</u>

ARCHITECTURAL ITEMS:

ITEM NO. A1: Refer to Sheet G0.0:

1. Reissued sheet.

ITEM NO. A2: Refer to Sheet G2.0:

1. Sheet re-issued.

ITEM NO. A3: Refer to Sheet G3.0:

1. Sheet re-issued.

ITEM NO. A4: Refer to Sheet LS1.0:

1. Sheet re-issued.

ITEM NO. A5: Refer to Sheet AD1.0:

1. Sheet re-issued.

ITEM NO. A6: Refer to Sheet A1.0:

1. Sheet re-issued.

ITEM NO. A7: Refer to Sheet A1.0A:

1. Sheet re-issued.

ITEM NO. A8: Refer to Sheet A1.1:

1. Sheet re-issued.

ITEM NO. A9: Refer to Sheet A1.2:

1. Sheet re-issued.

ITEM NO. A10: Refer to Sheet A1.3:

1. Sheet re-issued.

ITEM NO. A11: Refer to Sheet A2.0:

1. Sheet re-issued.

ITEM NO. A12: Refer to Sheet A3.0:

2. Sheet re-issued.

ITEM NO. A13: Refer to Sheet A4.0:

1. Sheet re-issued.

ITEM NO. A14: Refer to Sheet A4.1:

1. Sheet issued.

ITEM NO. A15: Refer to Sheet A9.1:

2. Sheet re-issued.

END OF ADDENDUM NO. 2

Cc: Mary Schultz, Macomb County

Ben Treppa, Macomb County Facilities & Operations

Anthony Torelli, Macomb County Dan Waters, Wakely Associates Ron Syme, Wakely Associates

enovation, Vic Wertz Buiding No.: 242053 04 urchasine 31. 2024 ommissioners Bid Set, Date -

MACOMB COUNTY BOARD OF COMMISSIONERS



ENGINEER SEAL

ARCHITECT SEAL:

VIC WERTZ BUILDING

ISSUED FOR: BID SET

OCTOBER 31, 2024 DATE:

PROJECT NO.: 242053

ARCHITECT:

WAKELY ASSOCIATES, INC./ ARCHITECTS 30500 VAN DYKE AVE, SUITE 209, WARREN, MI 48093, 586.573.4100

MECHANICAL/ ELECTRICAL ENGINEERS:




UNIFIED BUILDING SYSTEMS ENGINEERING, LLC 75 N. MAIN ST. SUITE 221, MT. CLEMENS, MI 48043, 248.804.1741


STRUCTURAL ENGINEER:

ANDERSON, ECKSTEIN, & WESTRICK, INC. 51301 SCHOENHERR RD, SHELBY TOWNSHIP, MI 48315, 586.726.1234

Index of Drawings COVER SHEET, BUILDING ADDRESS & LOCATION MAP DEMOLITION PLANS COMPOSITE FLOOR PLAN - FIRST FLOOR AND SECOND FLOOR REFLECTED CEILING PLAN SECTIONS DOOR, FINISH, AND SIGNAGE SCHEDULES MECHANICAL GENERAL INFORMATION MECHANICAL COMPOSITE FIRST AND SECOND FLOOR PLANS PLUMBING DEMOLITION FIRST FLOOR PLAN MECHANICAL DEMOLITION FIRST FLOOR PLAN MD2.10 MECHANICAL DEMOLITION ROOF PLAN

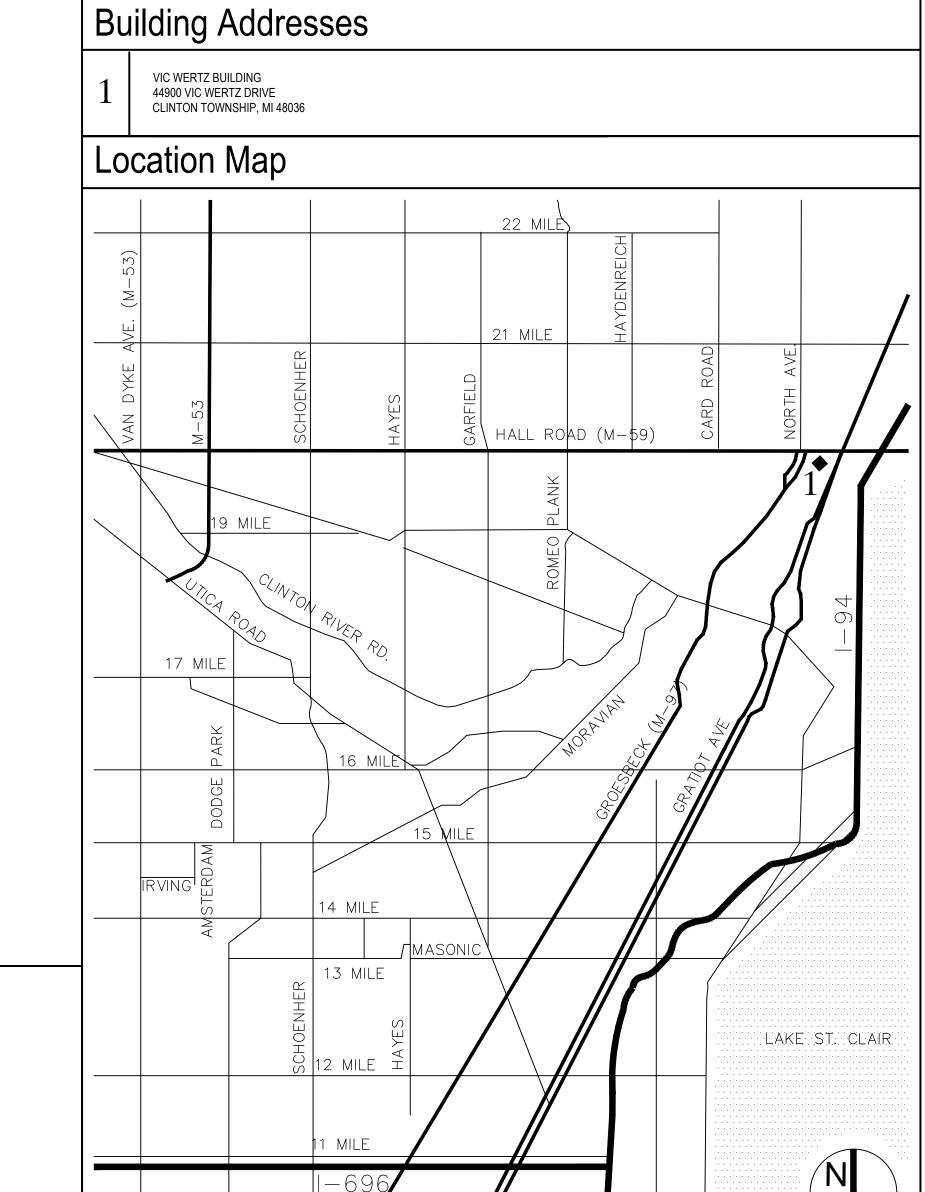

	ARCHITECTURAL ABBREVIATION LIST							
ABBREVIATION	DESCRIPTION	ABBREVIATION	DESCRIPTION DESCRIPTION	ABBREVIATION	IN LIS I DESCRIPTION	ABBREVIATION	DESCRIPTION	
A/C & VENT	AIR CONDITIONING & VENTILATION ARCHITECT-ENGINEER	dB DBL ACT DR	DECIBEL DOUBLE ACTING DOOR	JC JT	JANITORS CLOSET	QT	QUARRY TILE	
A/E AB ABRSV	ARCHITECT-ENGINEER ARCHITECT BOLT ABRASIVE	DECON DEG	DOUBLE ACTING DOOR DECONTAMINATION DEGREE	JI	JOINT	R	RADIUS	
ABRSV THRESH ACI ACOUS INSUL	ABRASIVE THRESHOLD AMERICAN CONCRETE INSTITUTE ACOUSTICAL INSULATION	DEMO DEPT DET	DEMONOLISH DEMOLITION DEPARTMENT DETAIL	L L LAB	ANGLE LENGTH LABORATORY	R RB RC	RISER RESILENT BASE ROOF CONDUCTOR	
ACOUS PNL ACS DR	ACOUSTICAL PANEL ACCESS DOOR	DF DIA	DRINKING FOUNTAIN DIAMETER	LAB LAM LAV	LABORATORY LAMINATED LAVATORY	RCPTR RCVG	RECEPTOR RECEIVING	
ACS PNL ACST ACST SLNT	ACCESS PANEL ACOUSTIC ACOUSTICAL SEALANT	DIAG DIAPH DIFF	DIAGONAL DIAPHRAGM DIFFUSER	LBS LG LH	LABORATORY LONG LEFT HAND	REC REF REF	RECESS OR RECESSED REFERENCE REFRIGERATOR	
ADA ADDL	ACOUSTICAL SEALANT AMERICANS W/ DISABILITIES ACT ADDITIONAL	DIM DIST	DIMENSION DISTANCE	LH LHR LN	LEFT HAND LEFT HAND REVERSE LINEAR	REG REINF	REFRIGERATOR REGISTER REINFORCE OR REINFORCED	
ADDM ADDN	ADDENDUM ADDITION ADJACENT	DW DL DMF	DISTILLED WATER DEAD LOAD DAMPROOFING	LKR LLH	LOCKER ROOM LONG LEG HORIZONTAL LONG LEG VERTICAL	REV RF RFG	REVISION RADIOGRAPHY & FLOUROSCOPY ROOFING	
ADJ ADJS AFF	ADJACENT ADJUSTABLE ABOVE FINISHED FLOOR	DN DO	DOWN DOOR OPENING OR DATA OUTLET	LLV LO LPT	LOUVER OPENING LOW POINTLTLIGHT	RFO RH	ROOFING ROOF OPENING RIGHT HAND	
AGGR AHU ALT	AGGREGATE AIR HANDLING UNIT ALTERATIONS	DR DRP DRW	DOOR DECAY RETARDANT PLYWOOD DECAY RETARDANT WOOD	LT WT LTG LVR	LIGHTWEIGHT LIGHTING LOUVER	RHB RHR RM	ROOF HOSE BOX RIGHT HAND REVERSE ROOM	
ALUM ANES	ALUMINUM ANESTHESIA, ANESTESIOLOGY	DRW DS DT	DOWNSPOUT DRAIN TILE	LVK		RND RO	ROUND ROUGH OPENING	
ANOD ANSI	ANODIZED AMERICAN NATIONAL STANDARDS INSTITUTE ACOUSTICAL PANAL CEILING	DW DWG	DISTILED WATER DRAWING	MACH MAG MAR	MACHINE MAGNET OR MAGNETIC	RR RS	RAILROAD ROOF SUMP	
APC APPROX ARCH	ACOUSTICAL PANAL CEILING APPROXIMATE ARCHITECTURAL	DWL	DOWEL	MAS MATL	MARBLE MASONARY MATERIAL	RSF RTF RTNG	RESILIENT SHEET FLOORING RESILIENT TILE FLOORING RETAINING	
ASPH ASTM	ASPHALT AMERICAN SOCIETY FOR TESTING MATERIALS	E EA	EAST EACH	MAX MB	MAXIMUM MARKER BOARD	RTU RV RVS	ROOF TOP UNIT ROOF VENTILATOR REVERSE	
ATC AUTO AVG	ACOUSTICAL TILE CEILING AUTOMATIC AVERAGE	EF EIFS EJ	EACH FACE EXTERIOR INSULATION & FINISH SYSTEM EXPANDING JOINT	MBC MC MCA	MICHIGAN BUILDING CODE MICELLANEOUS CHANNEL MEDICAL COMRESSED AIR	RVS	REVERSE	
D DI	DACE DI ATE	EKG EL	ELECTRO-CARDIOGRAM ELEVATION	MCL MCP	METAL CEILING (LINER) METAL CEILING (PAN)	S S	SOUTH S-SHAPE STEEL MEMBER SOUND ATTENUATION BLANKET	
B PL B/B BC	BASE PLATE BACK TO BACK BOTTOM CHORD	ELEC ELEV EMBED	ELECTRICAL OR ELECTRONIC ELEVATOR EMBEDMENT	MECH MED MEMB	MECHCANICAL MEDICAL MEMBRANE	SAB SAF SB	SOUND ATTENUATION BLANKET SPRAY APPLIED FIREPROOFING SOIL BORING	
BD BEV	BOARD BEVELED	EMER EMER SHR	EMERGENCY SHOWER	MEMB RFG MEZZ	MEMBRANE ROOFING MEZZANINE	SCHED SDG	SCHEDULE SIDING	
BF BF BITUM	BARRIER FREE BOTH FACES BITUMINOUS	EMER SHR/EWS ENCL ENTR	EMERGENCY SHOWER/EYE WASH ENCLOSURE ENTRANCE	MFG MH MIN	MANUFACTURING MANHOLE MINIMUM	SE SECT SECY	SOUTHEAST SECTION SECRETARY	
BL BLDG	BUILDING LINE BUILDING	EQ EQUIP	EQUAL EQUIPMENT	MISC MO	MISCELLANEOUS MASONRY OPENING	SGFT SH	STRUCTURAL GLAZED FACING TILE SHOWER	
BLDG DAT BLKG BLW	BUILDING DATUM BLOCKING BELOW	ER ETR EW	EMERGENCY ROOM EXISITING TO REMAIN EACH WAY	MOD BIT MR MRI	MODIFIED BITUMEN MOISTURE RESISTANT MAGNETIC RESONANCE IMAGING	SHT SI SIM	SHEET STEEL & IRON WORK SIMILAR	
BM BOS	BEAM BOTTOM OF STEEL	EWC EWH	ELECTRIC WATER COOLER ELECTRIC WATER HEATER	MRT MTC	MARBLE THRESHOLD METAL TOILET COMPARTMENT	SLDG SLDG WDW	SLIDING SLIDING WINDOW	
BOT BR BRKT	BOTTOM BEDROOM BRACKET	EWS EX EXC	EYE WASH STATION EXISTING EXCAVATE	MTD MTL MTL FAB	MOUNTED METALIC OR METAL METAL FABRICATIONS	SLNT SLV SM	SEALANT SHORT LEG VERTICAL SHEET METAL	
BRZ BS	BRONZE BOTH SIDES	EXH EXIST	EXHAUST EXISTING	MULL	MULLION	SP SPEC	SHAFT PARTITION SPECIFICATION	
BSMT BT BTWN	BASEMENT BENT BETWEEN	EXTR	EXTRUDED	N N2	NORTH NITROGEN	SPKLR SQ SSK	SPRINKLER SQUARE SERVICE SINK	
BULLN BUR	BULLETIN BUILT-UP ROOFING	F/F FD	FACE TO FACE FLOOR DRAIN	N20 NARC	NITROUS OXIDE NARCOTICS	SST STA	STAINLESS STEEL STATION	
С	CHANNEL	FE FEC FH	FIRE EXTINGUSHER FIRE EXTINGUSHER CABINET FLAT HEAD	NATL NC NE	NATIONAL NOISE CRITERIA NORTH EAST	STAG STC STD	STAGGERED SOUND TRANSMISSION CLASS STANDARD	
C TO C CA	CENTER TO CENTER COMPRESSED AIR	FHR FIN	FIRE HOSE RACK/ REEL FINSIH OR FINISHED	NFPA NIC	NATIONAL FIRE PROTECTIONA ASSOCIATION NOT IN CONTACT	STIF STL	STIFFENER STEEL	
CAB CANTL CATH	CABINET CANTILEVER CATHETERIZE CATHETER	FIP FIXT FJ	FOAMED-IN-PLACE FIXTURE FALSE JOINT	NL NO NOM	NIGHT LIGHT NUMBER OR NUMBERS NOMINAL	STOR STRUCT STRUCT STL	STORAGE STRUCTURAL STRUCTURAL STEEL	Λ.
CB CEM	CATCH BASIN CEMENT	FLASH FLG	FLASHING FLANGE	NOUR NS	NOURISHMENT NURSE STATION	SURF SUSP	SURFACE SUSPENDED OR SUSPENSION	<u>AF</u>
CER CF/CI CF/OI	CERAMIC CONTRACTOR FURNISHED/ CONTRACTOR INSTALLED	FLR FM FNDN	FLOOR FACTORY MUTUAL FOUNDATION	NSF NW	NATIONAL SANITATION FOUNDATION NORTHWEST	SV SW	SHEET VINYL SOUTH WEST SWITCH	SYMBOL
CF/OI CFMF CG	CONTRACTOR FURNISHED/ OWNER INSALLED COLD-FORMED METAL FRAMING CORNER GUARD	FOC FR	FACE OF COLUMN FIRE RATED	O2	OXYGEN	SW SWD-FR SYM	SWITCH SHEATHING WOOD-FIRE RETARDANT SYMMETRICAL	N
CH CH BD	CORNER HOOK CHALK BOARD	FRP FRPFG	FIRE RATED PLYWOOD FIREPROOFING	O/O OBS	OUT TO OUT OBSERVATION		TDEAD	
CHKD CI CR	CHECKERED CAST IRON CIRCLE CIRCULAR CIRCULATION	FRW FT FTG	FIRE RATED WOOD FOOT OR FEET FOOTING	OBSC GL OBW OC	OBSCURE GLASS OBSERVATION WINDOW ON CENTER		TREAD TOUNGUE & GROOVE TREAD & RISER	
CL CL	CONTROL JOINT CENTERLINE	FURN	FURNITURE	OD OF	OUTSIDE DIAMETER OUTSIDE FACE	TA TB	TOILET ACCESSORIES TACK BOARD	OFFICE
CLG CLIN CLO	CEILING CLINICAL CLOSET	g GA	GRAM GAUGE	OF/CI OF/OI OFF	OWNER FURNISHED/ CONTRACTOR INSTALLED OWNER FURNISHED/ OWNER INSTALLED OFFICE	TBD TEL TEMP	TO BE DETERMINED TELEPHONE TEMPERATURE	OFFICE 101
CLR CMU	CLEAR CONCRETE MASONARY UNIT	GALV GCW	GALVANIZED GLAZED CURTAINWALL	OFRC OFRS	OVERFLOW ROOF CONDUCTOR COVERFLOW ROOF SUMP	TERR THD	TERRAZZO THREAD	-
CNVR CO	CONVEYOR CLEANOUT CARBON DIOXIDE	GDR GEN GFCI	GUARDRAIL GENERAL GROUND FAULT CIRCUIT INTERRUPTER	OH DR OPH OPNG	OVERHEAD DOOR OPPOSITE HAND	THK THRESH	THICK OR THICKNESS THRESHOLD TACKBOARD	5
CO2 COL COMO	CARBON DIOXIDE COLUMN COMPOSITION	GFRP GHT	GLASS-FIBER REINFORCED PLSTIC GLAZED HOLLOW TILE	OPP ORIG	OPENING OPPOSITE ORIGINAL	TK BD TOC TOIL	TACKBOARD TOP OF CONCRETE (ELEVATION) TOILET	8 5 6 A2.
CONC CONF	CONCRETE CONFERENCE	GI GL	GALVANIZED IRON GLASS, GLAZING	ORN OSHA	ORNAMENTAL OCCUPATIONAL SAFETY & HEALTH ADMINISTRATION	TOIL RM TOR	TOILET ROOM TOP OF RAIL (ELEVATION)	•
CONN CONSTR CONSTR JT	CONNECTION CONSTRUCTION CONSTRUCTION JOINT	GR GR BM GRAD	GRADE GRADE BEAM GRADIENT	Oz	OUNCE	TOS TOW TRAN	TOP OF STEEL (ELEVATION) TOP OF WALL (ELEVATION) TRANSOM	10 A4.3
CONT CONTR	CONTINUATION, CONTINUE, CONTINOUS CONTRACTOR	GRL GRTG	GRILLE GRATING	PACU PB	POST ANESTHESIA UNIT PUSH BUTTON	TV TYP	TELEVISION TYPICAL	
CORR CPRS CPS	CORRIDOR COMPRESSIBLE, COMPRESSED CARPET (SHEET)	GYO	GYPSUM	PC PEND PERF	PIECE OR PIECES PENDENT PERFORATED	UC	UNDERCABINET	A4.1 =
CPI CPW	CARPET (TILE) CARPET (WALL BASE)	H HB	HIGH HOSE BIBB	PERM PI	PERMANENT POINT OF INTERSECTION	UG UM	UNDERGROUND UNIT HEATER	
CR CR CRCMF	CARD READER CHAIR RAIL CIRCUMFERENCE	HD HDW HEX	HEAVY DUTY HARDWARE HEXAGON	PL PL GL PLAM	PROPERTY LINE PLATE GLASS PLASTIC LAMINATE	UL UN UNO	UNDERWRITERS LABORATORIES UNLESS NOTED UNLESS NOTED OTHERWISE	
CRIT CRS	CRITICAL COURSE	HM HNDRL	HOLLOW METAL HANDRAIL	PLAS PLBG	PLASTER PLUMBING	UR U/S	URINAL UNDERSIDE	
CSK CSS	COUNTER SINK CLINIC SERVICE SINK	HORIZ HOSP HPT	HORIZONTAL HOSPITAL HIGH POINT	PLT PLTC PLYD	PLATE OR PLATED PLASTIC LAMINATE TOILET COMPARTIMENT	VAC	VACUUM	4
CT CT CTB	CERAMIC TILE COMPUTED TOMOGRAHY CERAMIC TILE BASE	HR HSKPG	HOUR HOUSE KEEPING	PMF PNEU	PLYWOOD PERMANENT METAL FORM PNEUMATIC	VENT VERT	VACOUM VENTILATION OR VENTILATING VERTICAL	
CTR CTRD	CENTER CENTRAL CENTERED	HSS HT	HOLLOW STRUCTURAL SECTIONS HEIGHT	PNL PORC	PANEL PORCELAIN	VEST VIF	VESTIBULE VERIFY IN FIELD	
CTRL CU CW	CONTROL CUBIC COLD WATER	HTG HVAC HW	HEATING HEATING VENTAILATION AIR CONDITIONING HOT WATER	PORT POS PP	PORTABLE POSITION PANEL POINT	VIT VOL VTR	VITREOUS VOLUME VENT THROUGH ROOF	
		HWY HYD	HIGHWAY HYDRANT	PR PREFAB	PAIR PREFABRICATED	VWC	VINYL WALL COVERING	
				PREP PROC	PREPARATION PROCESS OR PROCESSING	W W W	WEST WIDE FLANGE SHAPES WIDE OR WIDTH	
						"		AC-1.0
								7

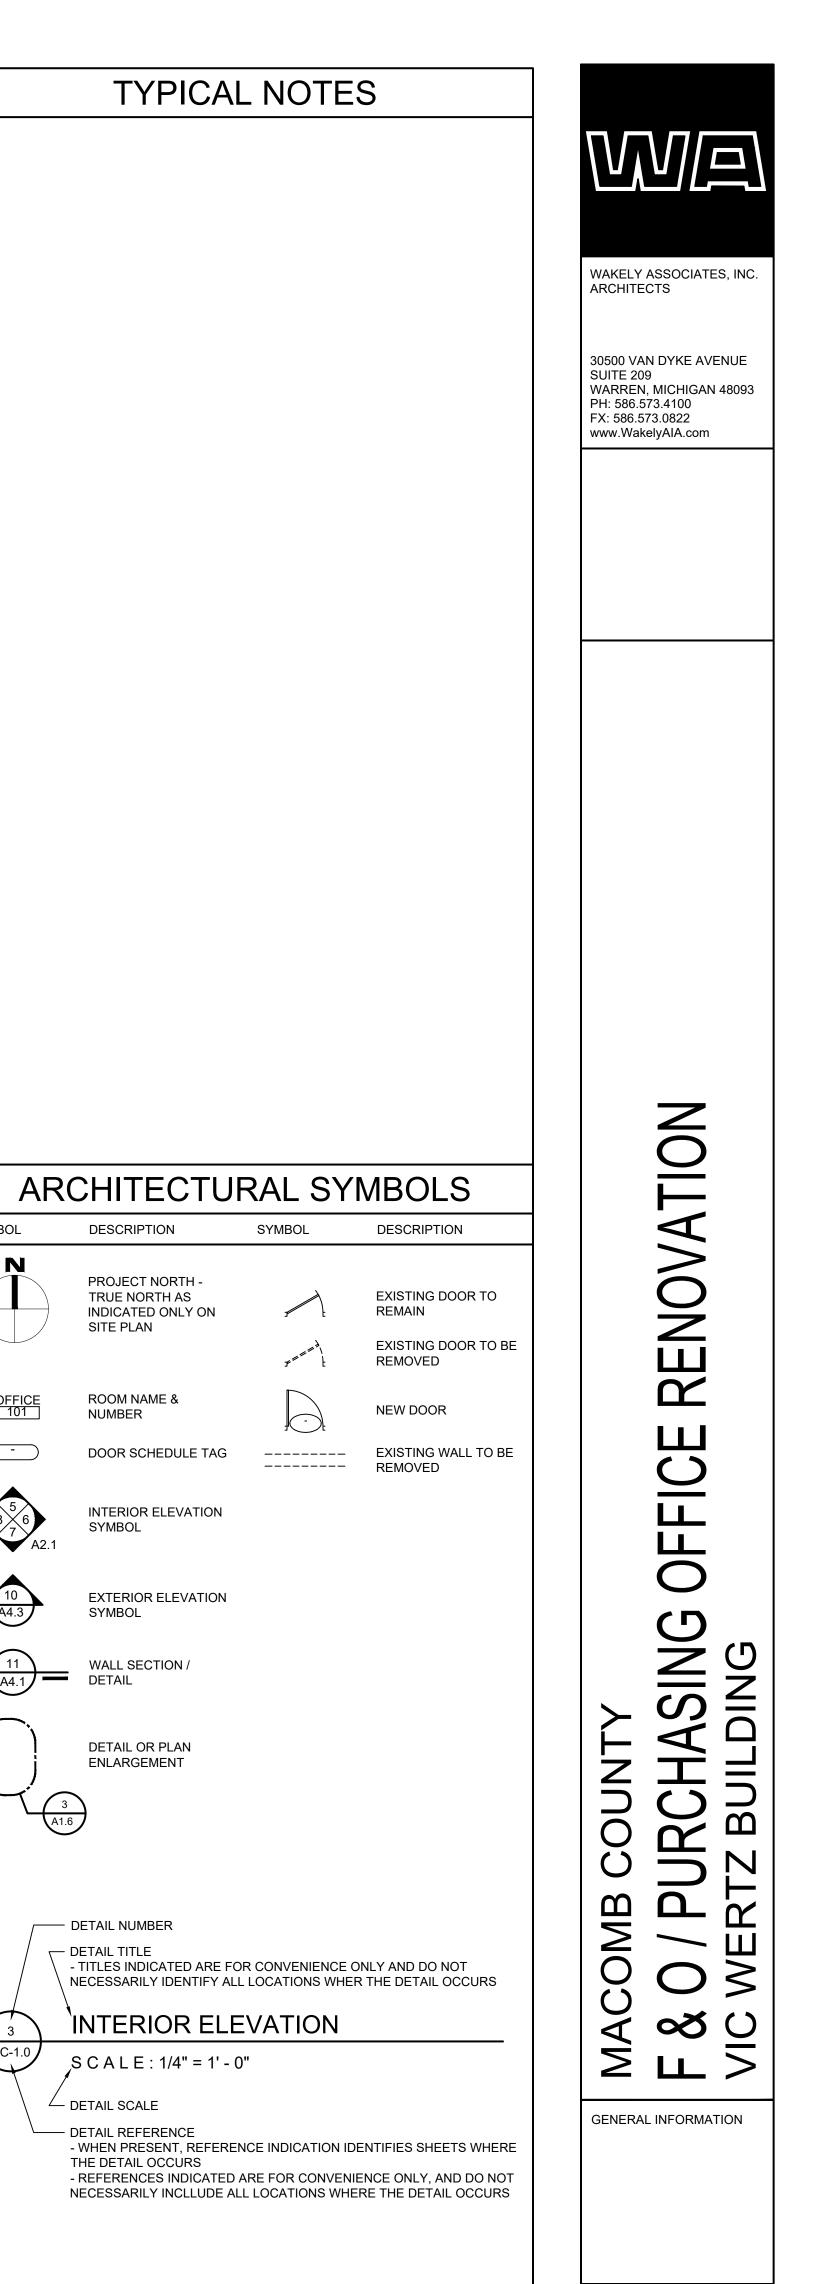

TYPICAL NOTES

DESCRIPTION

PROJECT NORTH -

TRUE NORTH AS
INDICATED ONLY ON
SITE PLAN

ROOM NAME &

INTERIOR ELEVATION

EXTERIOR ELEVATION SYMBOL

DETAIL OR PLAN **ENLARGEMENT**

____ DETAIL NUMBER C DETAIL TITLE

DETAIL REFERENCE

THE DETAIL OCCURS

INTERIOR ELEVATION

S C A L E : 1/4" = 1' - 0"

NUMBER

SYMBOL

WALL SECTION / DETAIL

SYMBOL

PRELIMINARY DESIGN DEVELOPMENT CONSTRUCTION FINAL RECORD DRAWN BY ____DCW/NL CHECKED BY__RS/DCW DATE: OCTOBER 31, 2024

> [G2.0] ^{JOB NO}242053

NEW WORK KEY NOTES - FLOOR PLAN:

- PROVIDE NEW SOFFIT DROP OVER ALL DEMOUNTABLE PARTITIONS IN PURCHASING AREA ONLY. (SEE DETAIL 13 ON SHT.
- REMOVE ALL GYP. BOARD AND TRIM AROUND WINDOWS. REPLACE EXISTING GYP. BRD. AND WINDOW SILL WITH NEW SOLID SURFACE WINDOW SILL. CAULK BETWEEN DISSIMILAR MATERIALS.
- LOCATION OF NEW WALL HUNG TV (BY OWNER). PROVIDE REINFORCING IN DE-MOUNTABLE WALL. PROVIDE POWER AND DATA FOR NEW TV. (SEE ELEC. DRAWINGS)
- EXTEND NEW PARTITION INTO EXISTING WINDOW OPENING AND TIE INTO EXISTING MULLION. CAULK BETWEEN DIS-SIMILAR MATERIAL.
- BELOW WINDOW: FUR OUT EXISTING EXTERIOR WALL W/ 2" HAT CHANNELS. INSTALL 2" RIGID INSULATION OVER ENITRE WALL AND COVER WITH (1) LAYER OF $\frac{5}{8}$ " HIGH ABUSE GYP. BRD. PAINTED. ABOVE WINDOW: FUR OUT EXISTING WALL WITH 6" METAL STUDS AT 16" O.C. W/ 2" RIGID INSULATION FASTENED TO EXISTING EXTERIOR WALL. INSTALL 5" HIGH ABUSE GYPSUM BOARD PAINTED. CONSTRUCT POCKETS FOR ROLLER SHADES. COORDINATE WITH SHADE MANUFACTURER AND SUPPLIER. (SEE
- CONSTRUCT NEW 35" METAL STUD HEAD W/ MINERAL WOOL INSULATION AND (1) LAYER OF $\frac{5}{8}$ GYP. BRD. EACH SIDE (PAINTED) ABOVE ALL DEMOUNTABLE PARTITIONS IN PURCHASING AREA ONLY. F&O AREA IS OPEN TO EXISTING STRUCTURE.

DETAIL)

EXACT SIZE.

- CORE NEW HOLE IN EXISTING CONCRETE MASONRY WALL FOR NEW MECHANICAL SYSTEM. SEE MECHANICAL DRAWINGS FOR
- OPEN EXISTING CONCRETE MASONRY WALL FOR NEW MECHANICAL SYSTEM. SEE MECHANICAL DRAWINGS FOR EXACT SIZE. PROVIDE NEW PRE-CAST CONCRETE LINTEL FOR OPENING MIN. 8" BEARING EACH SIDE.
- STUFF ALL EXISTING PENETRATIONS IN EXISTING WALLS AND FIRE CAULK. INSTALL FIRE SPRAY ON ENTIRE CEILING IN VESTIBULE A103 FOR A 2 HR. FIRE SEPARATION.
- PREPARE EXISTING MASONRY WALL AND INSTALL 24"x12" PORCELAIN CERAMIC TILE ON WALL FROM FLOOR TO 8'-0" TALL. PAINT WALL ABOVE. INSTALL CUSTOM OPAQUE GLASS WITH ETCHED MACOMB HISTORY PROVIDED THROUGH THE COUNTY. PANELS OF GLASS SHALL BE INSTALLED WITH STAND-OFFS FASTENED TO THE NEW TILE AND MASONRY WALL.
- OPEN UP EXISTING GYPSUM BOARD WALLS FOR INSTALLATION OF NEW SANITARY LINE AND PLUMBING FIXTURES. REPAIR WALLS AS REQUIRED AND PAINT TO MATCH.
- INFILL EXISTING DOOR W/ $3\frac{5}{8}$ " MTL. STUDS AT 16" O.C. W/ SOUND ATTENUATING INSULATION AND (1) LAYER OF 5" HIGH ABUSE GYP. BRD. EACH SIDE PAINTED.
- PROVIDE 6" MIN. 3\frac{5}{8}" MTL. STUD CHASE FROM CEILING TO FLOOR FOR POWER AND OTHER ITEMS TO TRANSVERSE DOWN. (TYPICAL) INSTALL NEW CLUTCH OPERATED FLEX SHADE IN BOX OUT HEAD

DETAIL. (SEE DETAIL)

- DEMOLISH PORTION OF EXISTING ROOF TO PREPARE FOR NEW MECHANICAL CURB INSTALLATION. PROVIDE ALL REQUIREI SUPPORT STEEL FOR ROOF DUCTWORK PENETRATIONS. AFTER NEW CURB IS INSTALLED FLASH AND ROOF IN AS REQUIRED FOR A WATERTIGHT SOLUTION. EXISTING ROOF IS MANUFACTURED BY TREMCO. PROVIDE A CERTIFIED TREMCO INSTALLER TO PERFORM WORK SO WARRANTY IS NOT VOIDED. PROVIDE TREMCO APPROVED WALK MATS AROUND ENTIRE PERIMETER OF NEW ROOF TOP UNIT.
- DEMOLISH PORTION OF EXISTING ROOF TO PREPARE FOR NEW SUN DOME AND TUNNEL BY VELUX THROUGH THE EISEN GROUP 248-319-7763. PROVIDE REQUIRED CURB AND ROOF PENETRATION INCLUDING 4x3x₄¹" LLV SUPPORT STEEL ANGLE FOR OPENING. FLASH AND ROOF IN AS REQUIRED FOR A WATERTIGHT SOLUTION. EXISTING ROOF IS MANUFACTURED BY TREMCO. PROVIDE A CERTIFIED TREMCO INSTALLER TO PERFORM WORK SO WARRANTY IS NOT VOIDED.

DEMOLITION KEY NOTES - FLOOR PLAN:

- REMOVE EXISTING WOOD DOOR, FRAME AND HARDWARE COMPLETE. DISPOSE OF DOOR AND FRAME. SALVAGE ALL EXISTING HARDWARE AND HAND OVER TO OWNER.
- 2 REMOVE EXISTING WALL COMPLETE.
- /3\ REMOVE EXISTING FLOOR COVERING COMPLETE INCLUDING RUBBER
- 4\ REMOVE EXISTING LAY-IN CEILING COMPLETE. PREP FOR NEW LAY-IN CEILING AND LIGHTING. (SEE ELEC. DRAWINGS)
- √5 \ REMOVE TOILET AND PLUMBING COMPLETE. SAWCUT EXISTING CONC. FLOOR AS REQ'D. CAP EXISTING PLUMBING BELOW GRADE. PATCH
- 6 REMOVE SINK AND PLUMBING COMPLETE. OPEN EXISTING WALL AS REQ'D. CAP EXISTING PLUMBING BELOW GRADE. (SEE MECH. DRAWINGS)

EXISTING FLOOR AS REQUIRED. (SEE MECH. DRAWINGS)

- 7\ CUT A 4'-0"x4'-0" WINDOW IN EXISTING MASONRY WALL. PROVIDE NEW
- PRECAST LINTEL AT EACH OPENING W/ MIN. 8" BR'G. EACH SIDE.
- /8 REMOVE EXISTING WALLBOARD COMPLETE INCLUDING FURRING STRIPS.
- / 9 \ REMOVE EXISTING WINDOW SILL.
- /10\ REMOVE ALL EXISTING TOILET ROOM ACCESSORIES AND REPLACE WITH NEW. SEE PLAN DETAILS.
- INCLUDING ALL HARDWARE. PATCH EXISTING WALLS AS REQUIRED WITH LIKE MATERIALS.
- /12\ REMOVE EXISTING ALUMINUM VESTIBULE SYSTEM COMPLETE. PATCH ALL EXISTING WALLS AS REQUIRED WITH LIKE MATERIALS.
- /13\ SAWCUT AND REMOVE EXISTING CONCRETE FLOOR AS REQUIRED FOR NEW ELECTRICAL FLOOR BOX AND UNDERGROUND CONDUIT INSTALLATION. PROVIDE NEW 4" CONCRETE SLAB W/ #5 BARS (EACH SIDE) @12" O.C. EPOXY SET (EMBED 4" MIN.) ON 15 MIL. VAPOR BARRIER OVER 4" MIN. GRANULAR FILL. PROVIDE EXPANSION PAPER AS REQUIRED.
- SAWCUT AND REMOVE EXISTING CONCRETE FLOOR AS REQUIRED FOR NEW SANITARY LINE INSTALLATION. PROVIDE NEW 4" CONCRETE SLAB W/ #5 BARS (EACH SIDE) @12" O.C. EPOXY SET (EMBED 4" MIN.) ON 15 MIL. VAPOR BARRIER OVER 4" MIN. GRANULAR FILL. PROVIDE EXPANSION PAPER AS REQUIRED.
- REMOVE EXISTING GYPSUM BOARD COMPLETE INCLUDING FURRING DOWN TO EXTERIOR WALL. REMOVE FIN-TUBE RADIATION. COMPLETE (SEE MECH.)
- /16\ REMOVE EXISTING HORIZONTAL BLINDS AND HANGING HARDWARE COMPLETE.
- /17\ REMOVE EXISTING WALL AS REQUIRED FOR NEW DOOR INSTALLATION. PROVIDE NEW PRE-CAST LINTEL W/ MIN. 8" BR'G. EACH SIDE. TOOTH IN MASONRY AS REQUIRED. PAINT AFTER DOOR IS INSTALLED.

NEW WORK PLAN - GENERAL NOTES: (APPLIES TO ALL ROOMS)

- 1. ALL DIMENSIONS TO EXISTING ELEMENTS TO BE CONSIDERED +/- (V.I.F.) 2. PATCH, PREP, & PAINT ALL AREAS DISTURBED BY CONSTRUCTION.
- 3. REMOVE, SALVAGE, & REINSTALL ALL EXIST SIGNAGE ON EXIST DOORS TO BE REPLACED (VIF)
- 4. PREP & PAINT EXISTING CONSTRUCTION TO MATCH EXISTING AT ALL AREAS OF DEMO'D MECH / ELEC FIXTURES (I.E. SURFACE MOUNTED LIGHTS, EXIT LIGHTING, ELEC PANELS, ETC.)
- 5. REMOVE & REPLACE EXISTING ACOUSTIC CEILING TILES, GRILLES, REGISTERS, AND DIFFUSERS AS REQUIRED FOR NEW WORK - SEE MECH & ELEC DWGS.
- 6. ALL OUTSIDE CORNERS OF ALL NEW PLASTIC LAMINATE COUNTERTOP TO HAVE A RADIUS. 7. IN AREAS TO RECEIVE NEW FLOORING, CONTRACTOR TO PROTECT

EXISTING EQUIPMENT TO REMAIN (E.G., PROJECTORS, DIGITAL

DISPLAYS, SOUND SYSTEM AMPLIFIERS, WIRELESS ACCESS POINTS,


ETC.) IN EACH ROOM AFFECTED - BY OTHERS. 8. IN AREAS TO RECEIVE NEW CEILING SYSTEMS, CONTRACTOR TO TEMPORARILY SUPPORT & PROTECT EXISTING TECHNOLOGY EQUIPMENT TO REMAIN AS REQUIRED FOR NEW WORK IN EACH ROOM AFFECTED - BY OTHERS.

KEY NOTES LEGEND:

—QUANTITY OF SEGMENTS TO BE REPLACED (+/- 4'-1½" W - VIF)


←OPENING WIDTH (VIF) —OPENING HEIGHT (VIF)

LANDSCAPE LEGEND:

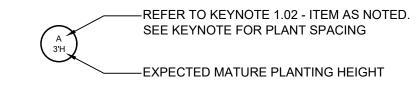

FLOOR PLAN LEGEND:



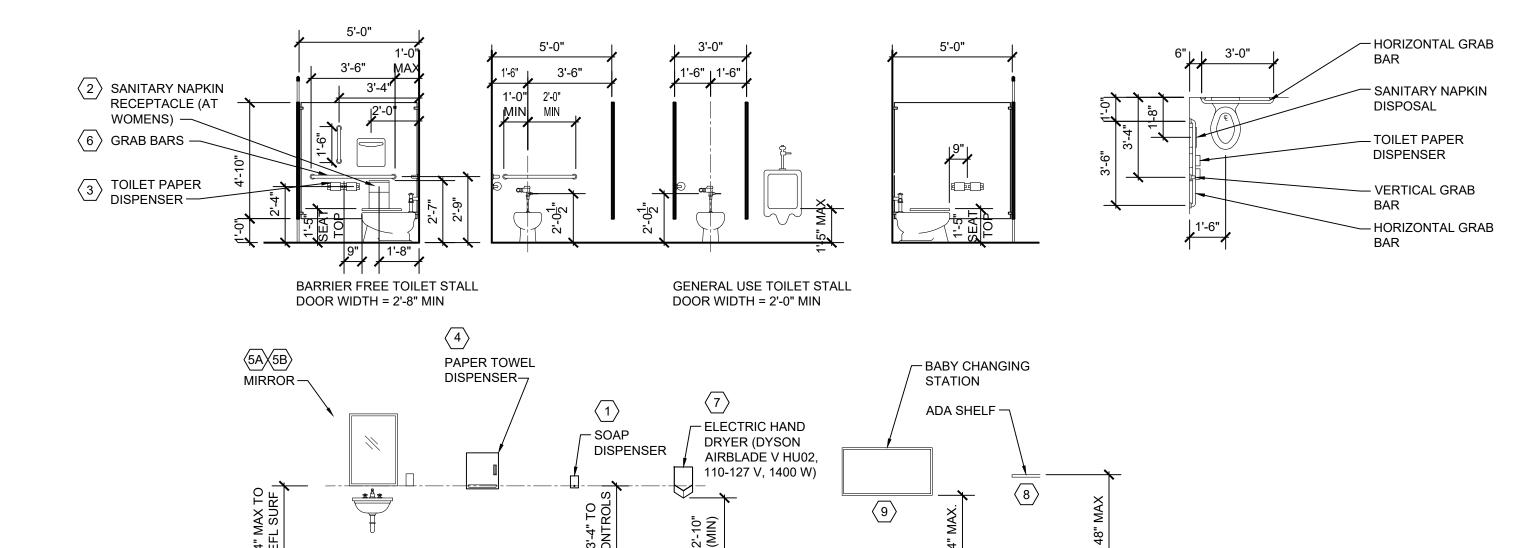

TOILET ROOM FIXTURES & ACCESSORIES

SCALE: 1/4" = 1'-0"

TOILET ACCESSORY KEYNOTES:

- (1) SOAP DISPENSER (OF/CI)
- (2) SANITARY NAPKIN DISPOSAL (CF/CI)
- (3) TOILET TISSUE DISPENSER (OF/CI)
- 4 PAPER TOWEL DISPENSER (OF/CI)
- (5A) MIRROR (CF/CI) (5B) MIRROR W/ SHELF (CF/CI)
- 6 GRAB BARS (CF/CI)
- (7) ELECTRIC HAND DRYER (CF/CI -
- SEE KEYNOTE 2.26) 8 ST. STL SHELF (CF/CI)
- (9) BABY CHANGING STATION

WAKELY ASSOCIATES, INC. ARCHITECTS 30500 VAN DYKE AVENUE

WARREN, MICHIGAN 48093

SUITE 209

PH: 586.573.4100

FX: 586.573.0822

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GENERAL NOTES, &

KEYNOTES

PRELIMINARY

CONSTRUCTION

DRAWN BY ___DCW/NL CHECKED BY RS/DCW

ADDENDUM No. 1 11-7-2024 ADDENDUM No. 2 11-11-202

DATE: OCTOBER 31, 2024


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242053

FINAL RECORD

REVISIONS

DESIGN DEVELOPMENT ☐

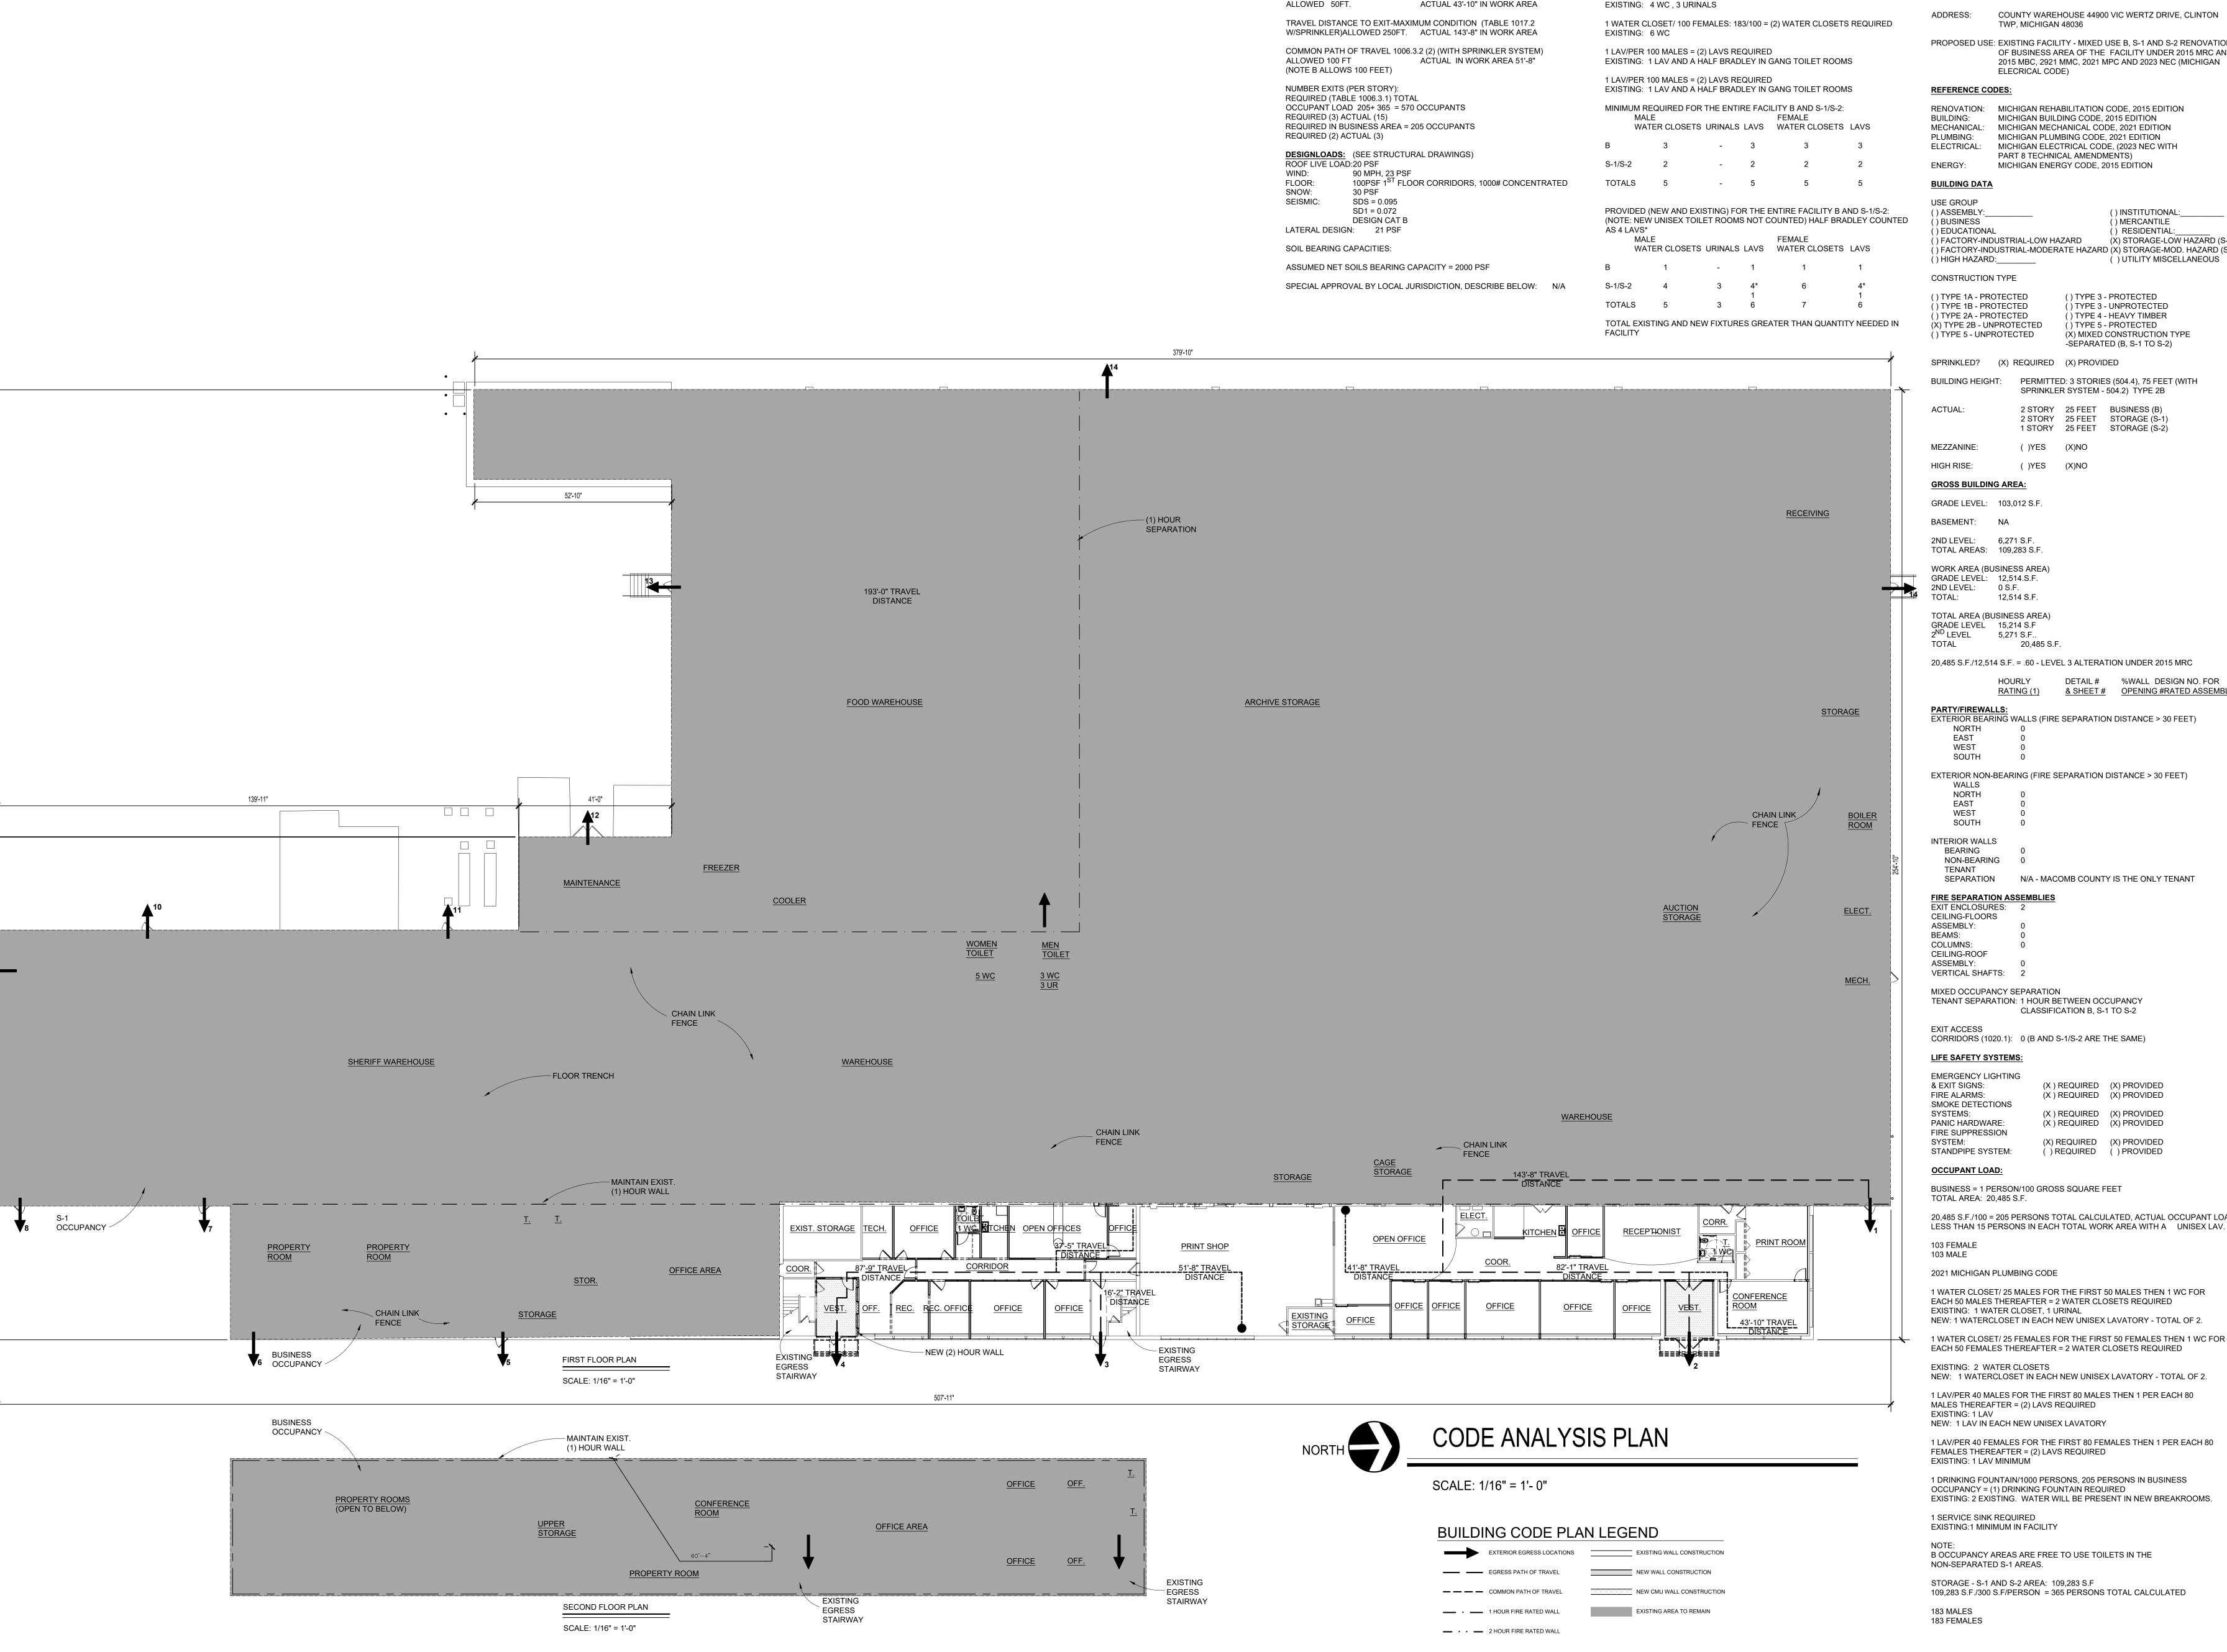

BUILDING CODE SUMMARY

PROJECT: MACOMB COUNTY - COUNTY WAREHOUSE FACILITIES AND OPERATIONS AND PURCHASING

BUILDING CODE SUMMARY CONT. BUILDING CODE SUMMARY CONT.

1 WATER CLOSET/ 100 MALES: 183/100 = (2) WATER CLOSETS REQUIRED

EXIT REQUIREMENTS (B AND S ARE THE SAME UNLESS NOTED OTHERWISE): 2021 MICHIGAN PLUMBING CODE

DEAD END LIMIT-MAXIMUM CONDITION (1020.4 W/EXCEPTION #2)

OFFICE RENOVATIONS RENOVATION

PROPOSED USE: EXISTING FACILITY - MIXED USE B, S-1 AND S-2 RENOVATION OF BUSINESS AREA OF THE FACILITY UNDER 2015 MRC AND

RENOVATION: MICHIGAN REHABILITATION CODE, 2015 EDITION MICHIGAN BUILDING CODE, 2015 EDITION MECHANICAL: MICHIGAN MECHANICAL CODE, 2021 EDITION PLUMBING: MICHIGAN PLUMBING CODE, 2021 EDITION ELECTRICAL: MICHIGAN ELECTRICAL CODE, (2023 NEC WITH PART 8 TECHNICAL AMENDMENTS)

() INSTITUTIONAL:_____ () MERCANTILE () RESIDENTIAL: (X) STORAGE-LOW HAZARD (S-2) () FACTORY-INDUSTRIAL-MODERATE HAZARD (X) STORAGE-MOD. HAZARD (S-1) () UTILITY MISCELLANEOUS

() TYPE 3 - PROTECTED () TYPE 3 - UNPROTECTED () TYPE 4 - HEAVY TIMBER () TYPE 5 - PROTECTED (X) MIXED CONSTRUCTION TYPE -SEPARATED (B, S-1 TO S-2)

PERMITTED: 3 STORIES (504.4), 75 FEET (WITH SPRINKLER SYSTEM - 504.2) TYPE 2B

2 STORY 25 FEET STORAGE (S-1) 1 STORY 25 FEET STORAGE (S-2)

20,485 S.F./12,514 S.F. = .60 - LEVEL 3 ALTERATION UNDER 2015 MRC

DETAIL # %WALL DESIGN NO. FOR <u>& SHEET # OPENING #RATED ASSEMBLIES</u>

EXTERIOR BEARING WALLS (FIRE SEPARATION DISTANCE > 30 FEET)

EXTERIOR NON-BEARING (FIRE SEPARATION DISTANCE > 30 FEET)

TENANT SEPARATION: 1 HOUR BETWEEN OCCUPANCY CLASSIFICATION B, S-1 TO S-2

CORRIDORS (1020.1): 0 (B AND S-1/S-2 ARE THE SAME)

(X) REQUIRED (X) PROVIDED (X) REQUIRED (X) PROVIDED (X) REQUIRED (X) PROVIDED

(X) REQUIRED (X) PROVIDED () REQUIRED () PROVIDED

BUSINESS = 1 PERSON/100 GROSS SQUARE FEET

20,485 S.F./100 = 205 PERSONS TOTAL CALCULATED, ACTUAL OCCUPANT LOAD LESS THAN 15 PERSONS IN EACH TOTAL WORK AREA WITH A UNISEX LAV.

1 WATER CLOSET/ 25 MALES FOR THE FIRST 50 MALES THEN 1 WC FOR EACH 50 MALES THEREAFTER = 2 WATER CLOSETS REQUIRED

1 WATER CLOSET/ 25 FEMALES FOR THE FIRST 50 FEMALES THEN 1 WC FOR EACH 50 FEMALES THEREAFTER = 2 WATER CLOSETS REQUIRED

NEW: 1 WATERCLOSET IN EACH NEW UNISEX LAVATORY - TOTAL OF 2.

1 LAV/PER 40 FEMALES FOR THE FIRST 80 FEMALES THEN 1 PER EACH 80

1 DRINKING FOUNTAIN/1000 PERSONS, 205 PERSONS IN BUSINESS OCCUPANCY = (1) DRINKING FOUNTAIN REQUIRED EXISTING: 2 EXISTING. WATER WILL BE PRESENT IN NEW BREAKROOMS.

B OCCUPANCY AREAS ARE FREE TO USE TOILETS IN THE

109,283 S.F./300 S.F/PERSON = 365 PERSONS TOTAL CALCULATED



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> ENO

CODE ANALYSIS PLAN

PRELIMINARY

DESIGN DEVELOPMENT [CONSTRUCTION FINAL RECORD

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ADDENDUM No. 1 11-7-202 ADDENDUM No. 2 11-11-20

DATE: OCTOBER 31, 2024 SHEET NO.

SEE SHEET G3.0 FOR ALL KEYNOTES.




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RENOVAT

OFFICE



MACOMB COUNTY
F & O / PURCHASING
VIC WERTZ BUILDING

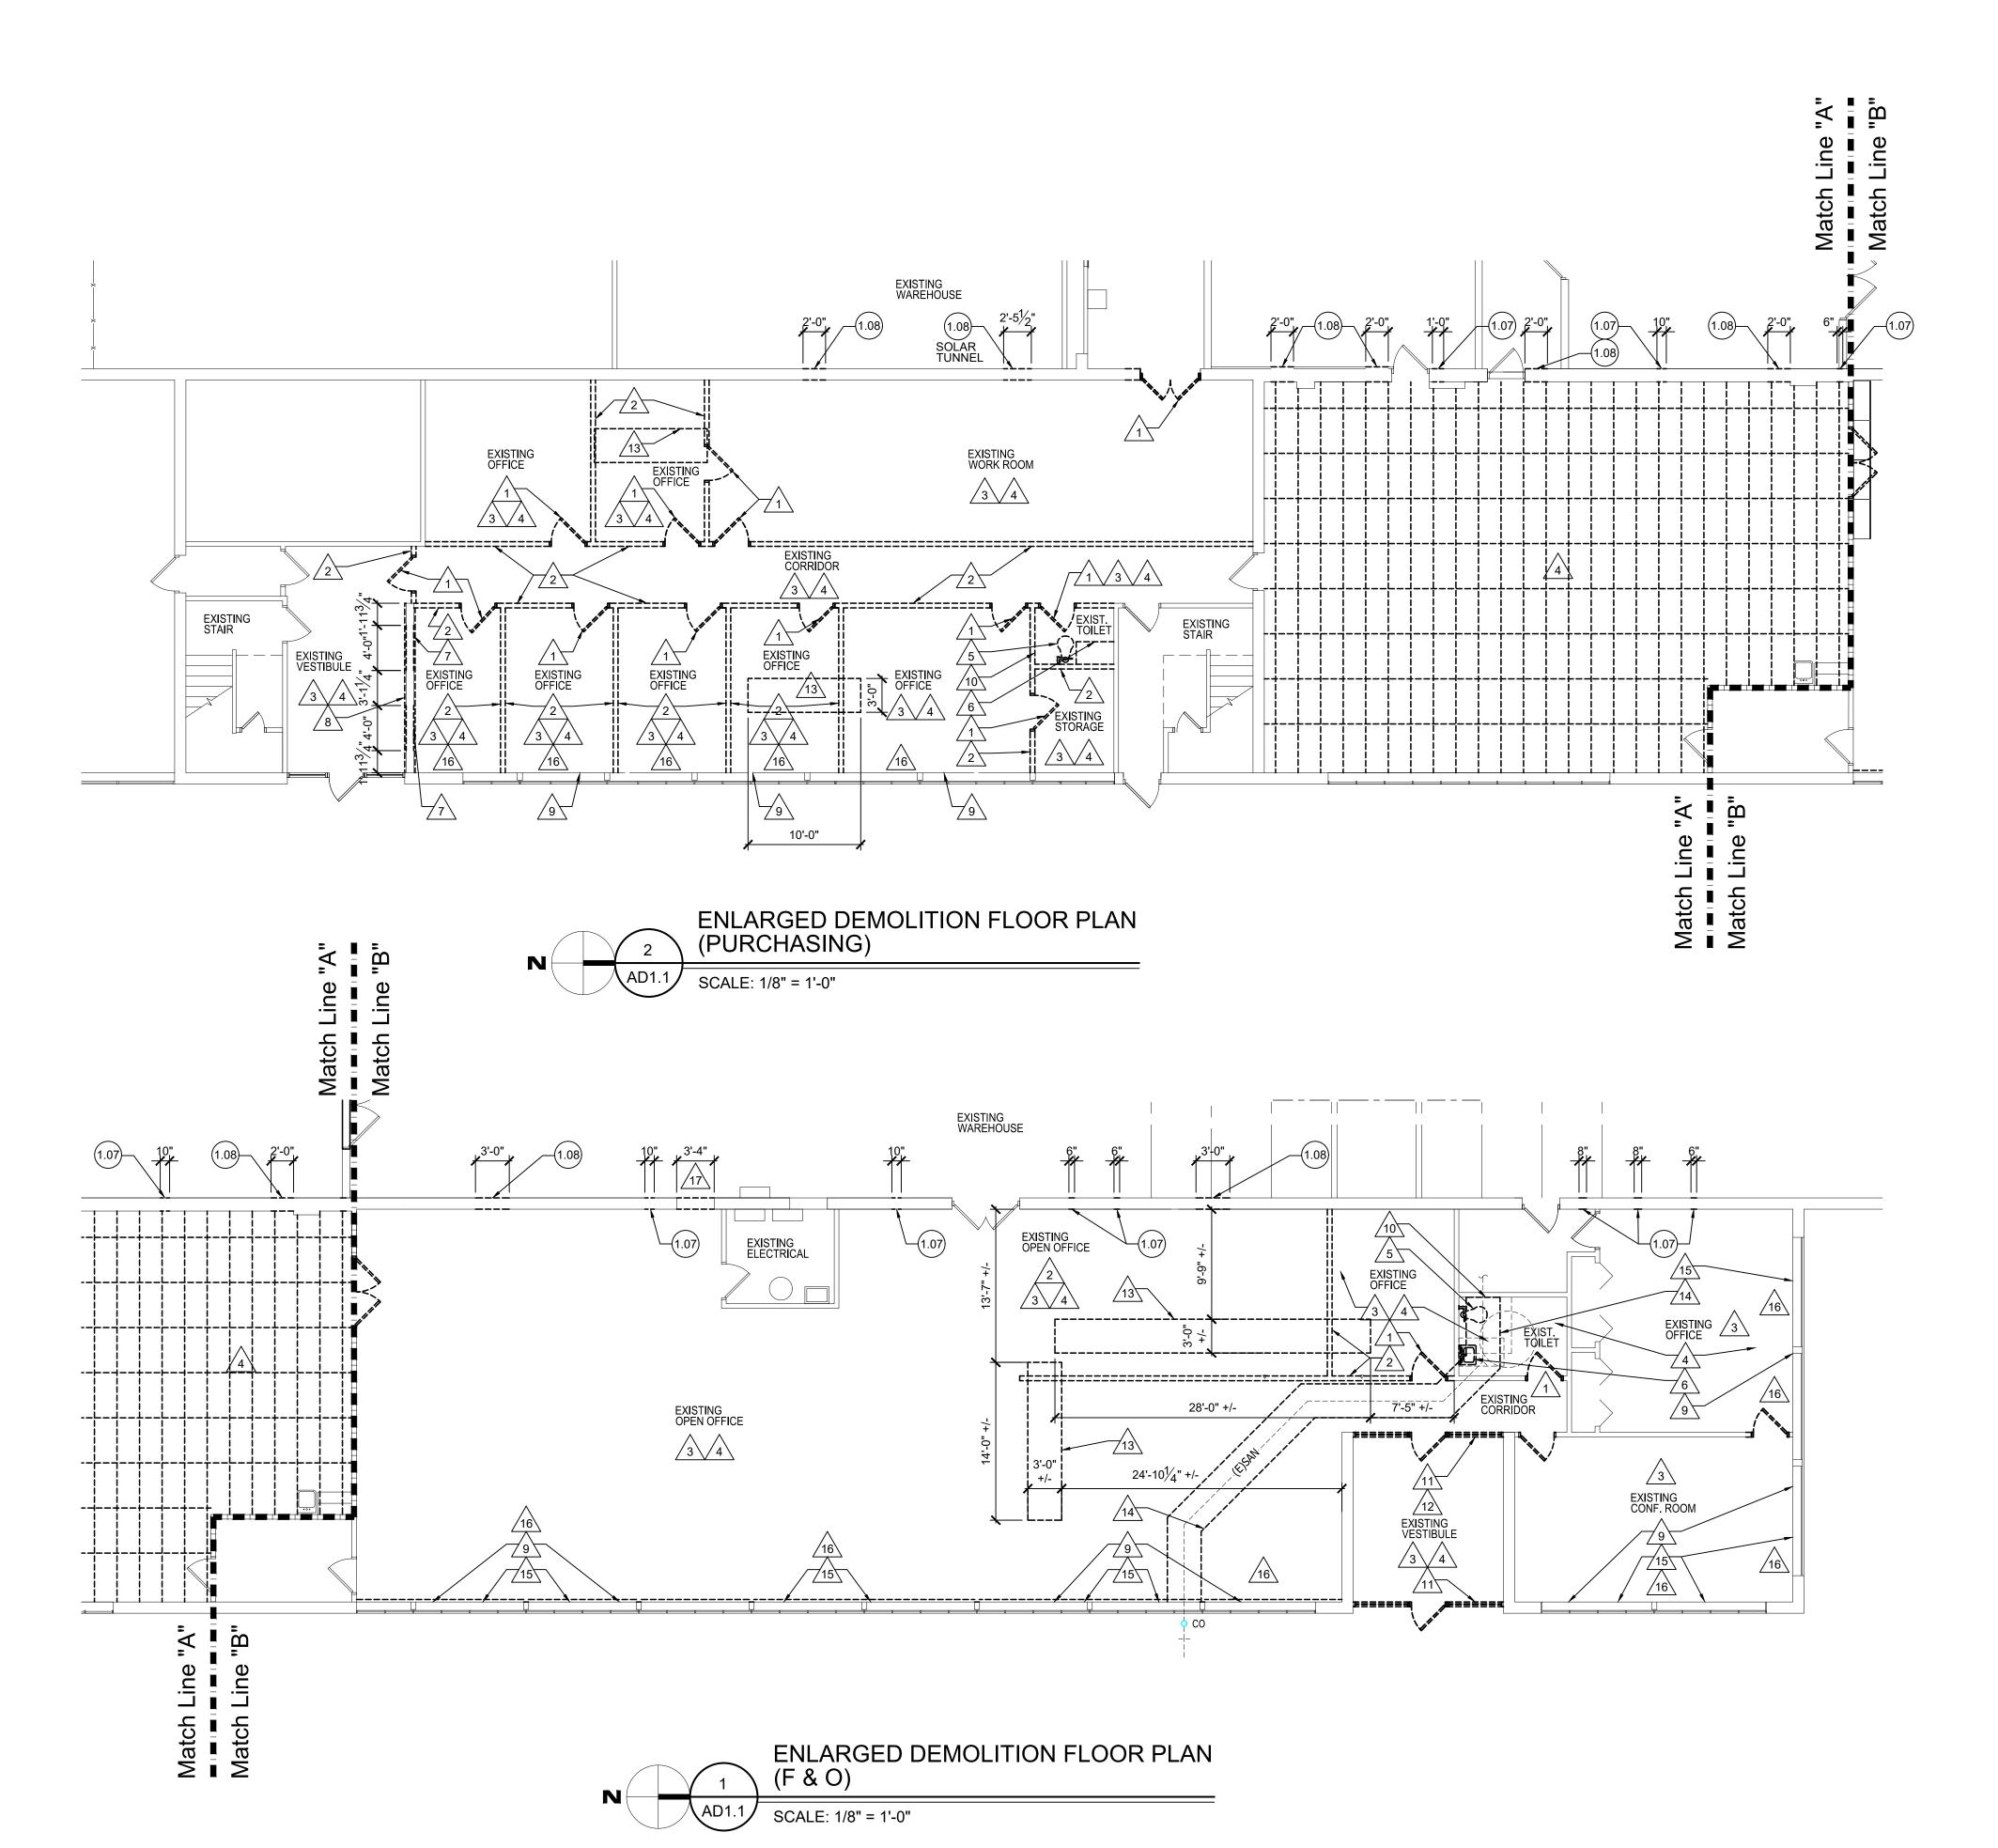PRELIMINARY
DESIGN DEVELOPMENT
CONSTRUCTION

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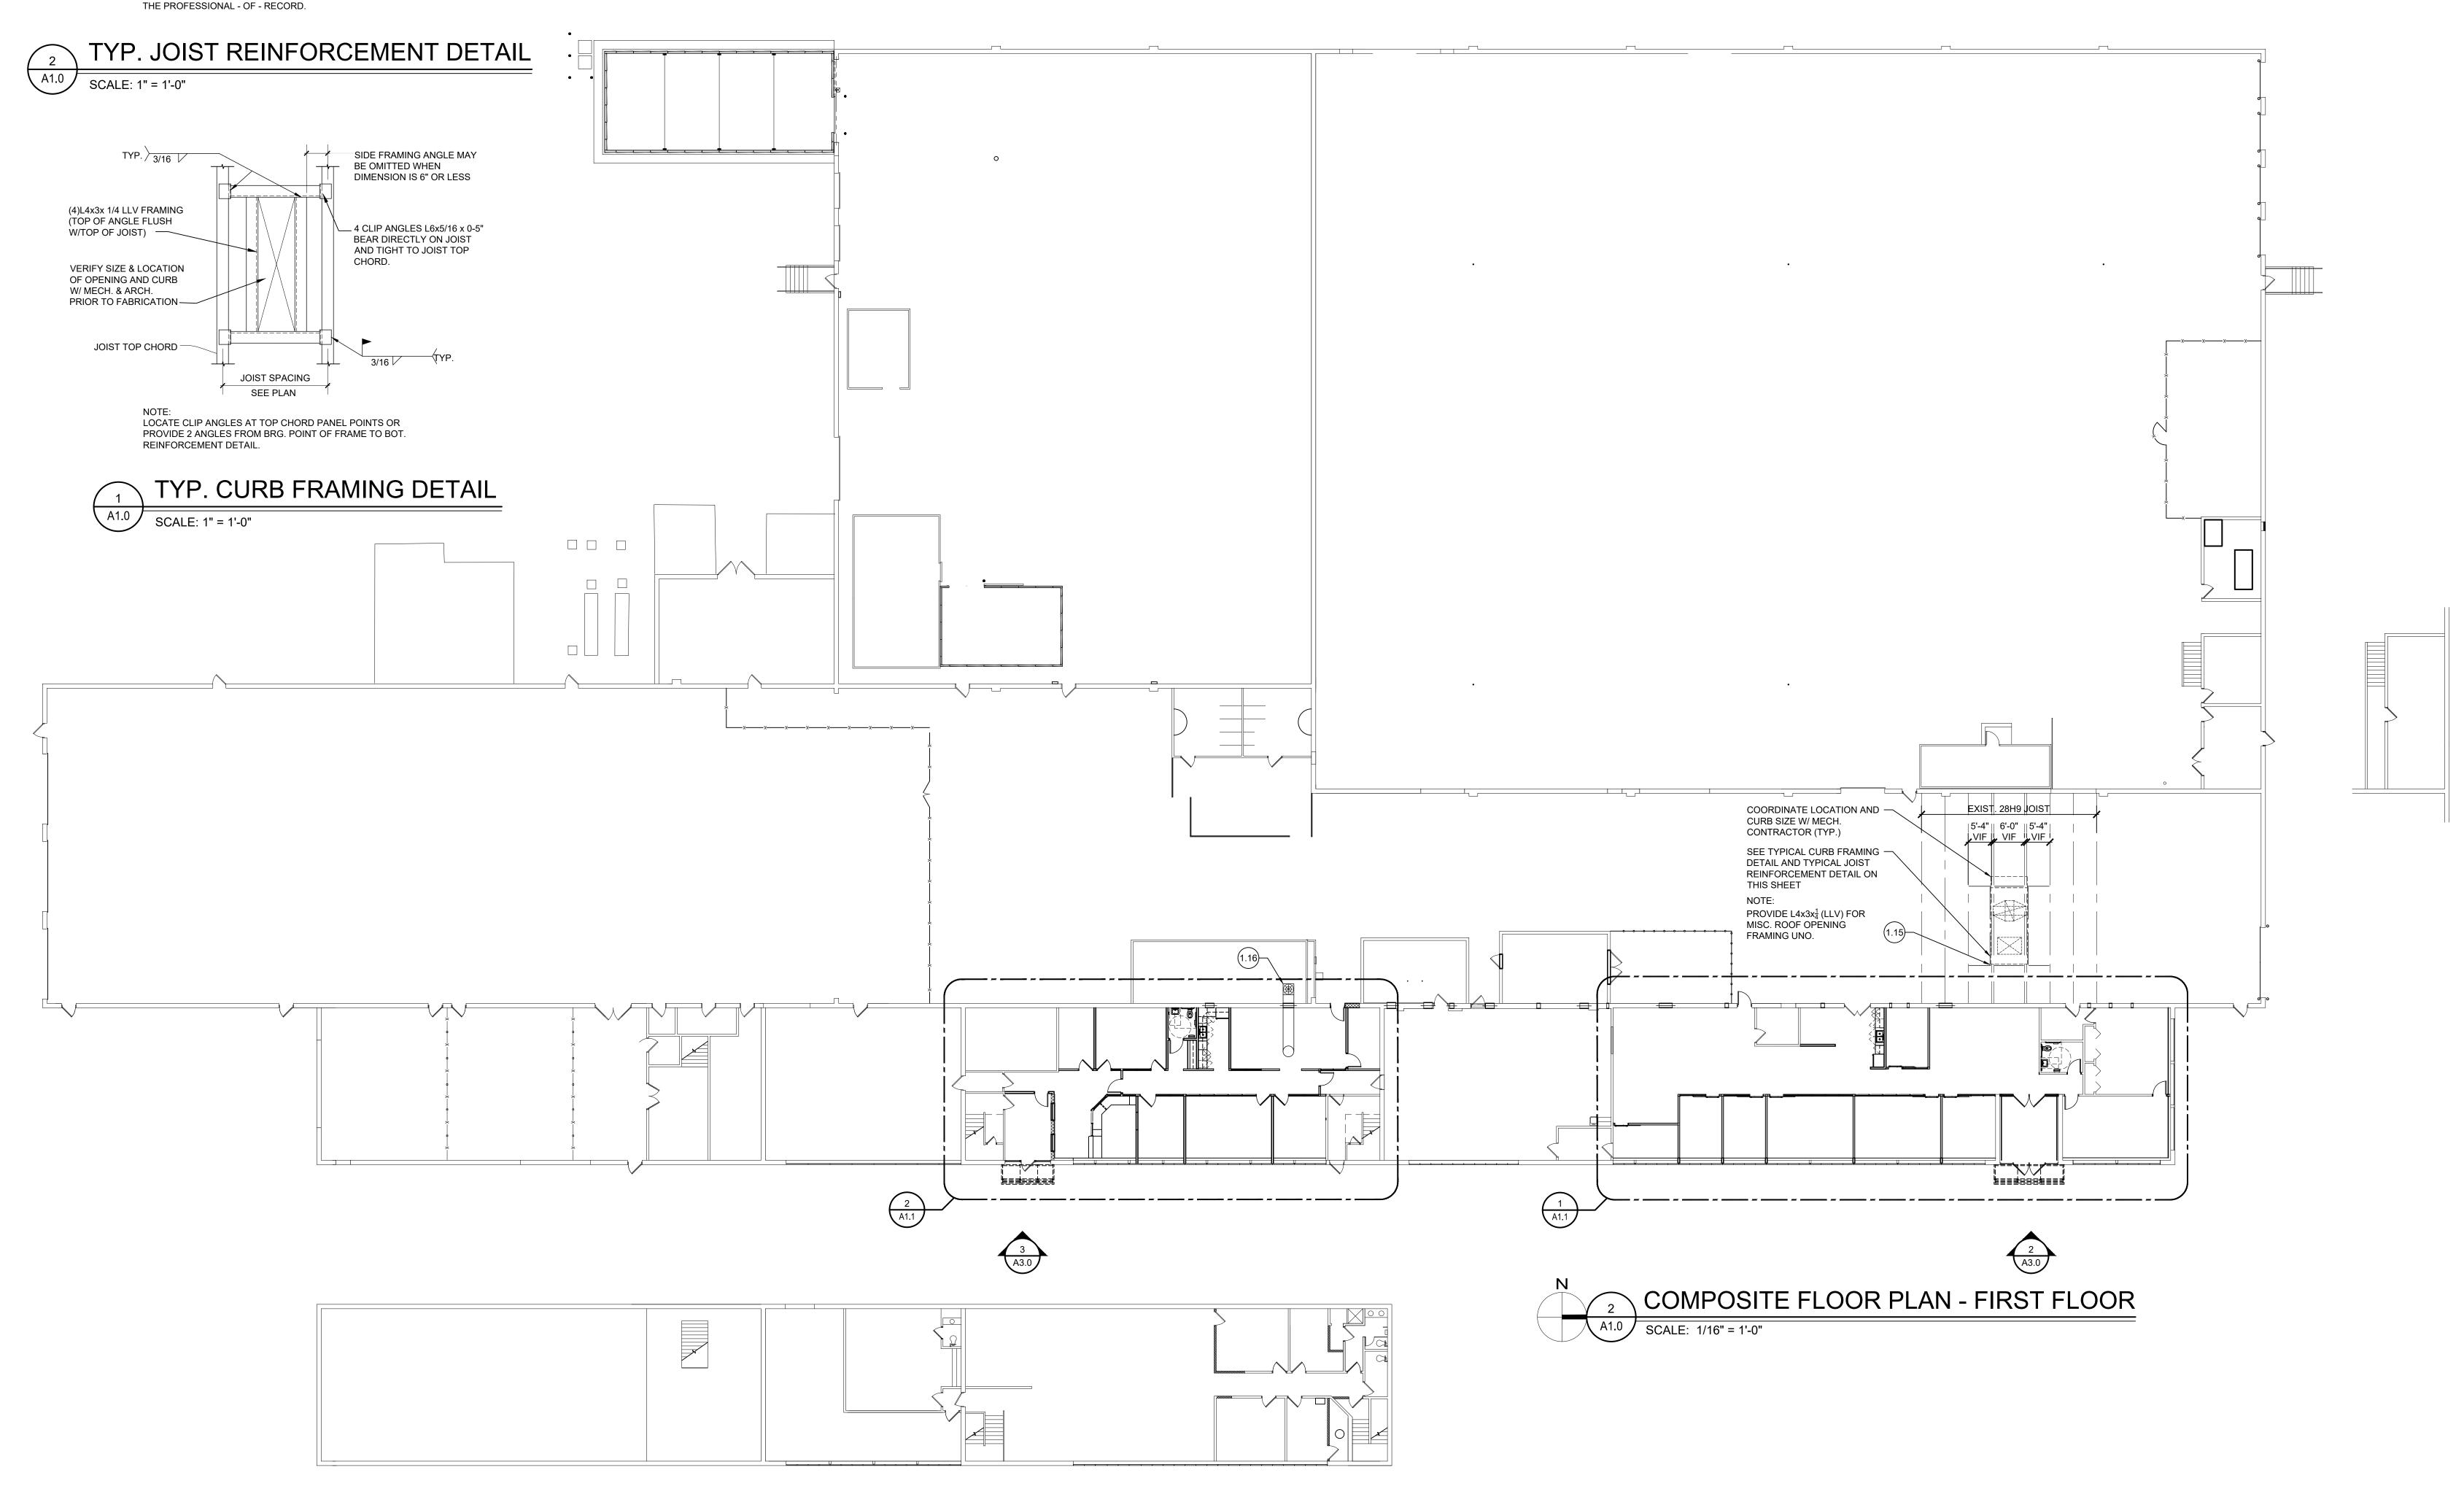
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ADDENDUM No. 1 11-7-2024
ADDENDUM No. 2 11-11-2024

DATE: OCTOBER 31, 2024 SHEET NO.

AD1.0

- NOTE:

 1. ALL ADDITIONAL SUPPLEMENTAL STRUT MUST BE INSTALLED IN STEEL JOISTS AT ALL CONCENTRATED LOADS IN EXCESS OF 50 LBS. UNLESS THE LOAD ATTACHMENT IS AT A PANEL POINT OF THE JOISTS.
- 2. AN ADDITIONAL STRUT IS NOT REQUIRED IF 'X' OR 'Y' IS LESS THAN OR EQUAL TO 6".
- 3. CONCENTRATED LOADS GREATER THAN 250 LBS, WHICH ARE NOT SPECIFIED ON THE PLANS, ARE NOT PERMITTED WITHOUT REVIEW BY







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MACOMB COUNTY

F & O / PURCHASING OFFICE RENOVATION

VIC WERT Z BILLI DING

COMPOSITE PLANS


PRELIMINARY
DESIGN DEVELOPMENT
CONSTRUCTION
FINAL RECORD


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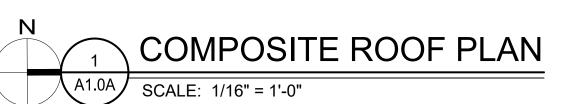
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ADDENDUM No. 1 11-7-2024
ADDENDUM No. 2 11-11-202

ADDENDUM No. 2 11-11

DATE: OCTOBER 31, 2024 SHEET NO.



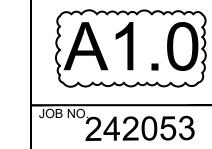

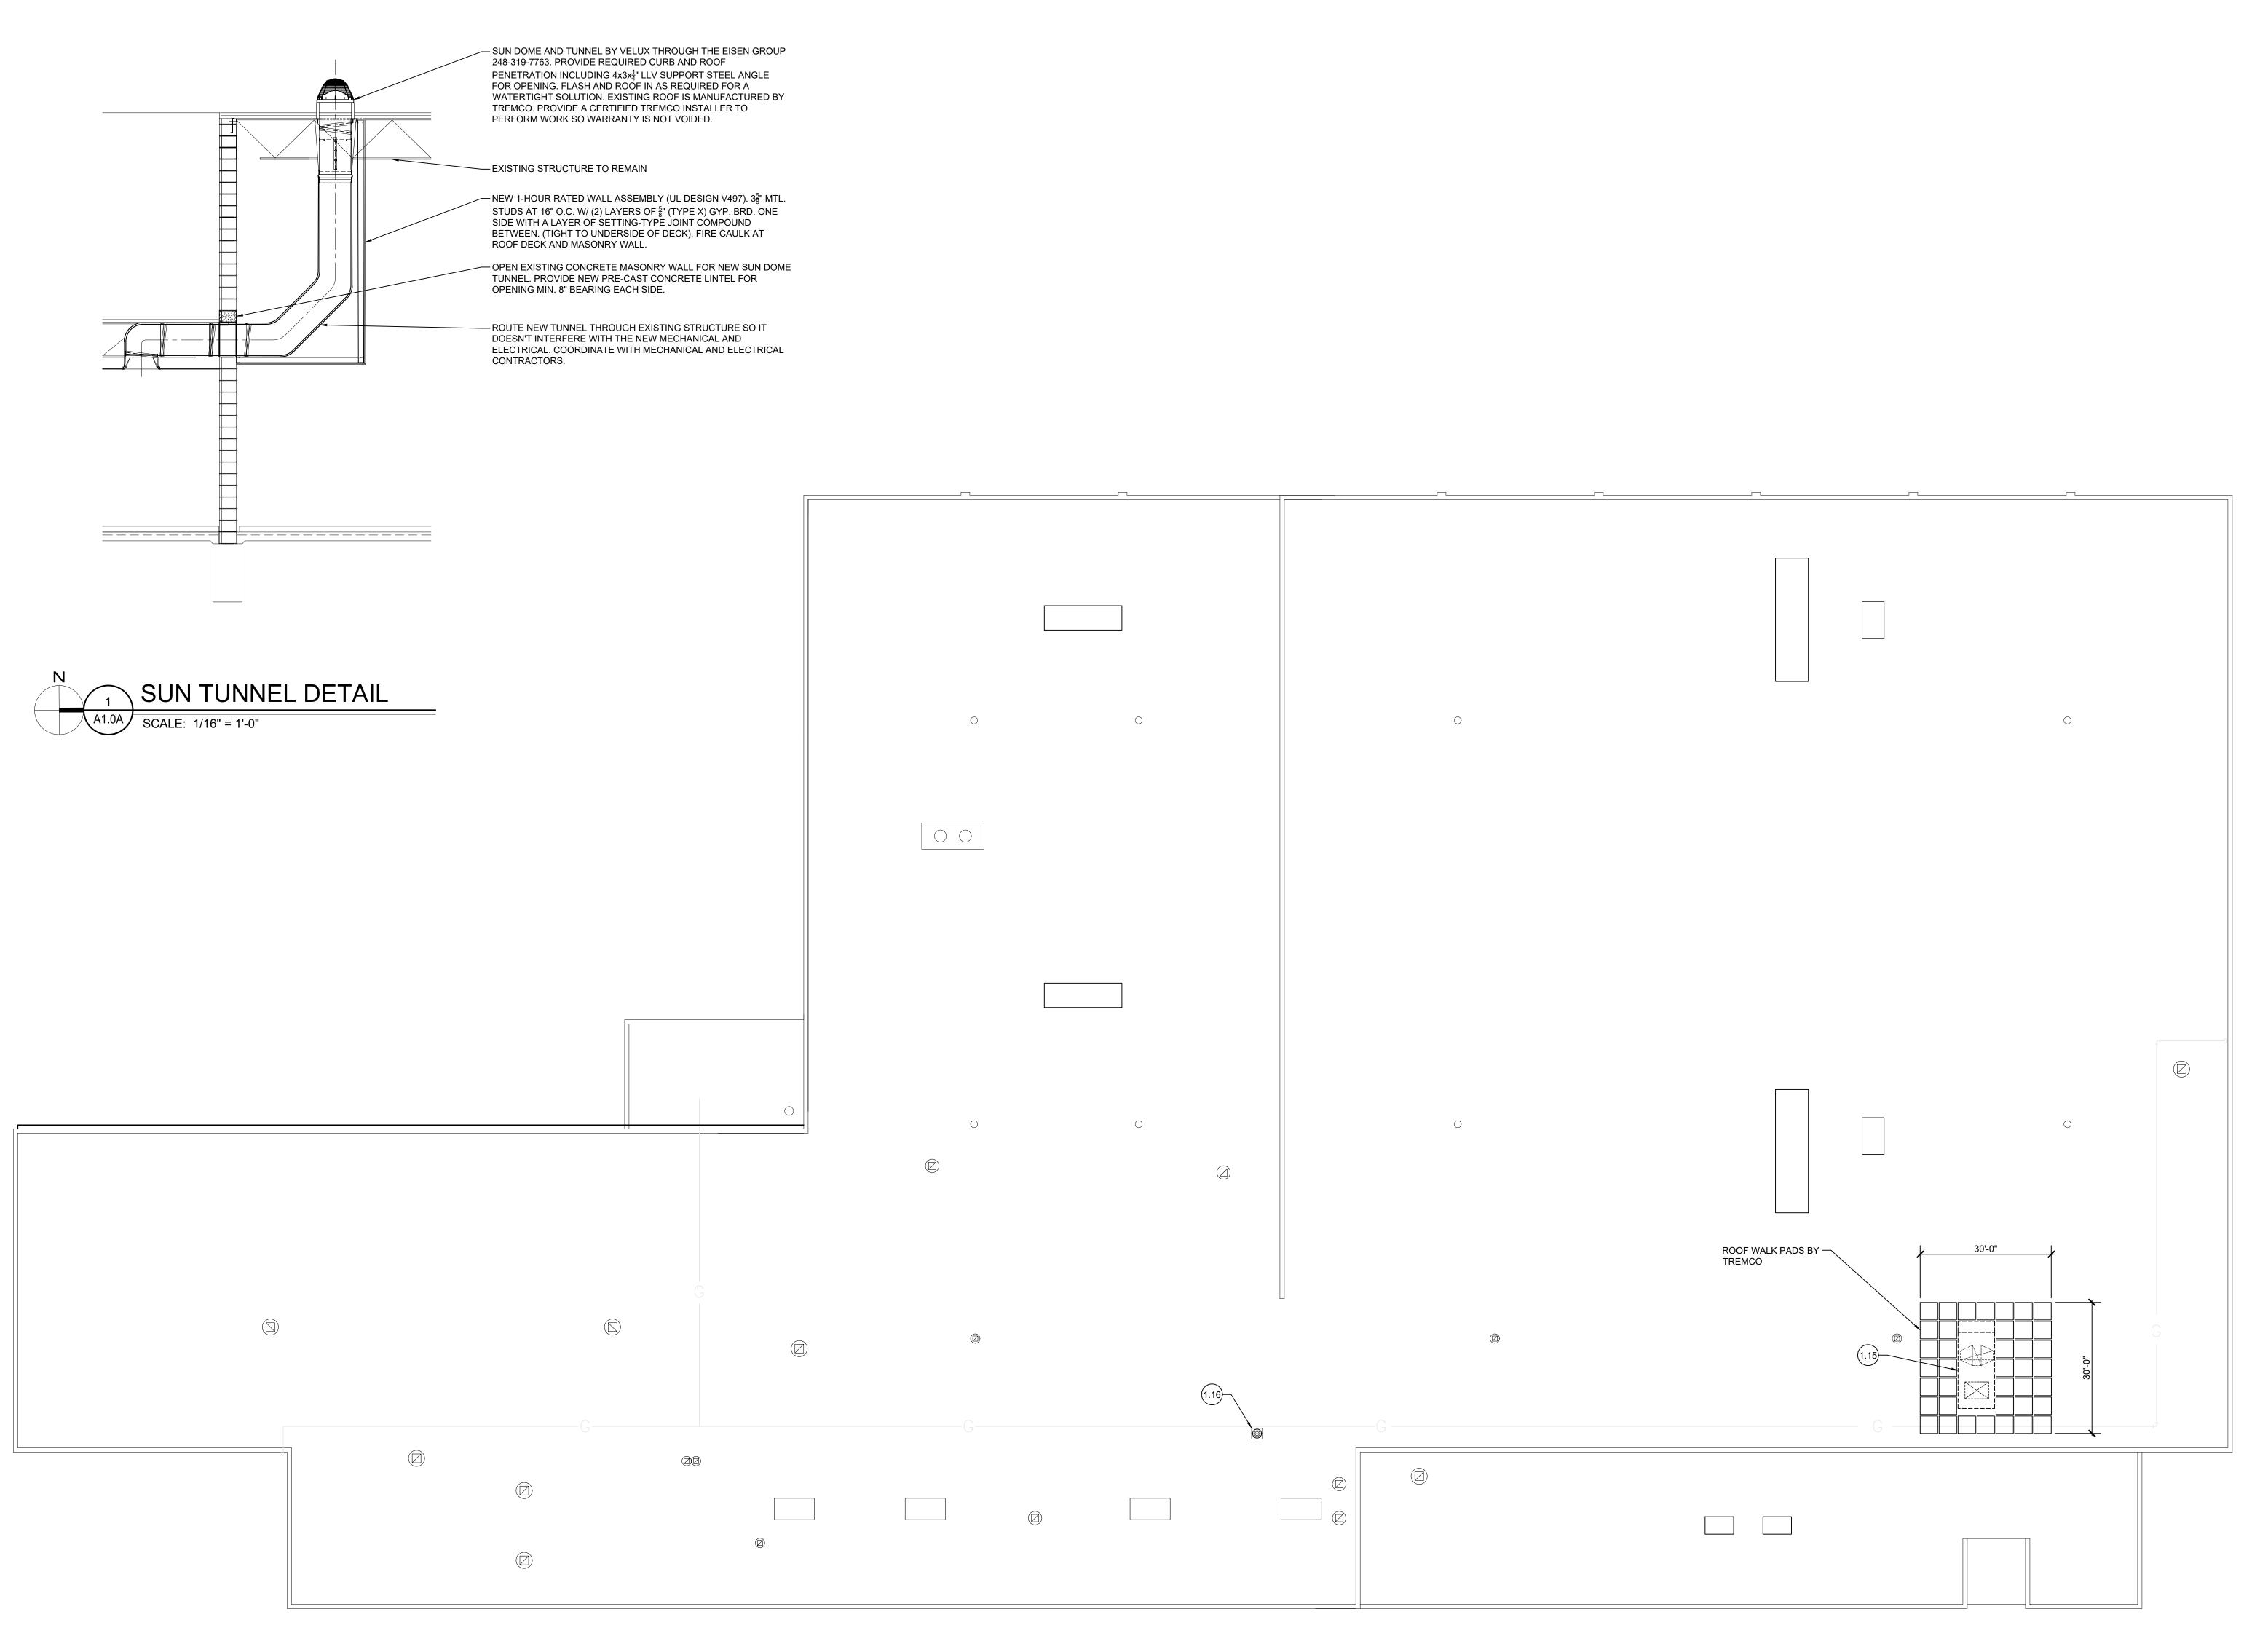



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VIC WERTZ BUILDING

COMPOSITE PLANS

PRELIMINARY
DESIGN DEVELOPMENT
CONSTRUCTION

FINAL RECORD


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ADDENDUM No. 2 11-11-2024

DATE: OCTOBER 31, 2024

MEET NO.

(A1.UA)

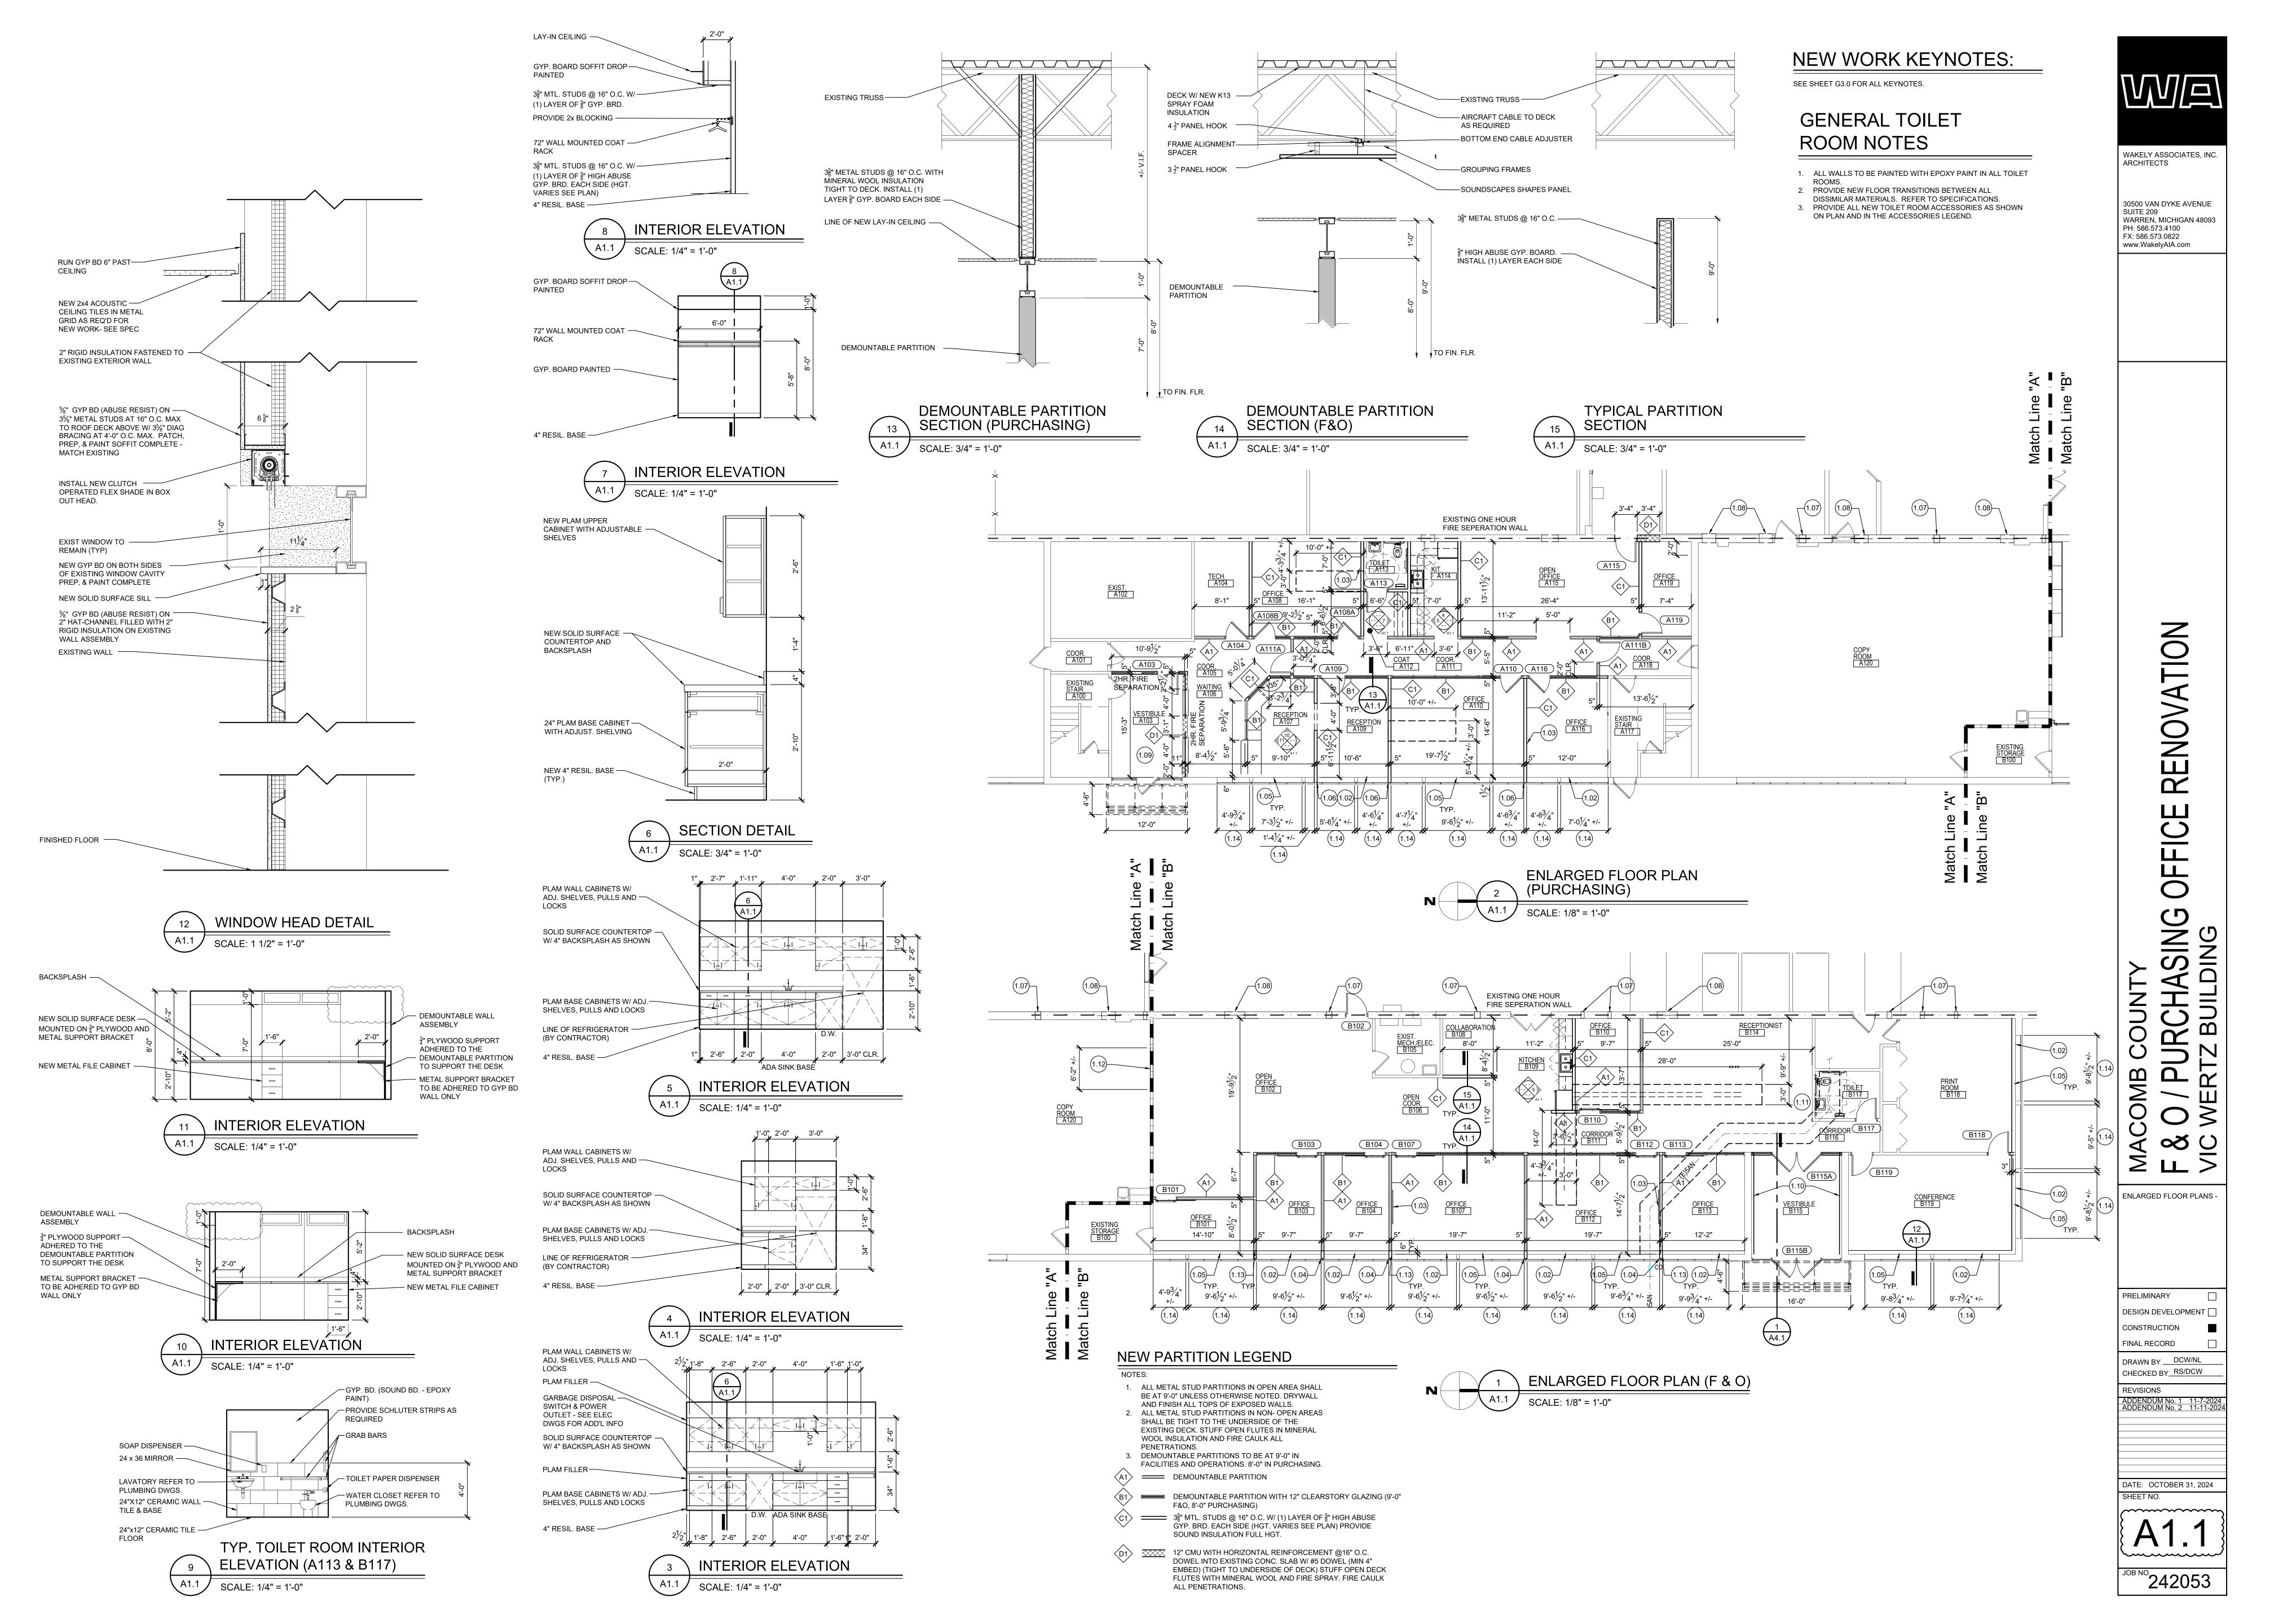

COAT COOR. (A111)

SCALE: 1/8" = 1'-0"

OFFICE B107

ENLARGED FLOOR FINISH PLAN (F & O)

A1.1 SCALE: 1/8" = 1'-0"

OFFICE A110

ENLARGED FLOOR FINISH PLAN (PURCHASING)

OFFICE A116

OFFICE B112

OFFICE B113

EXIST. A102




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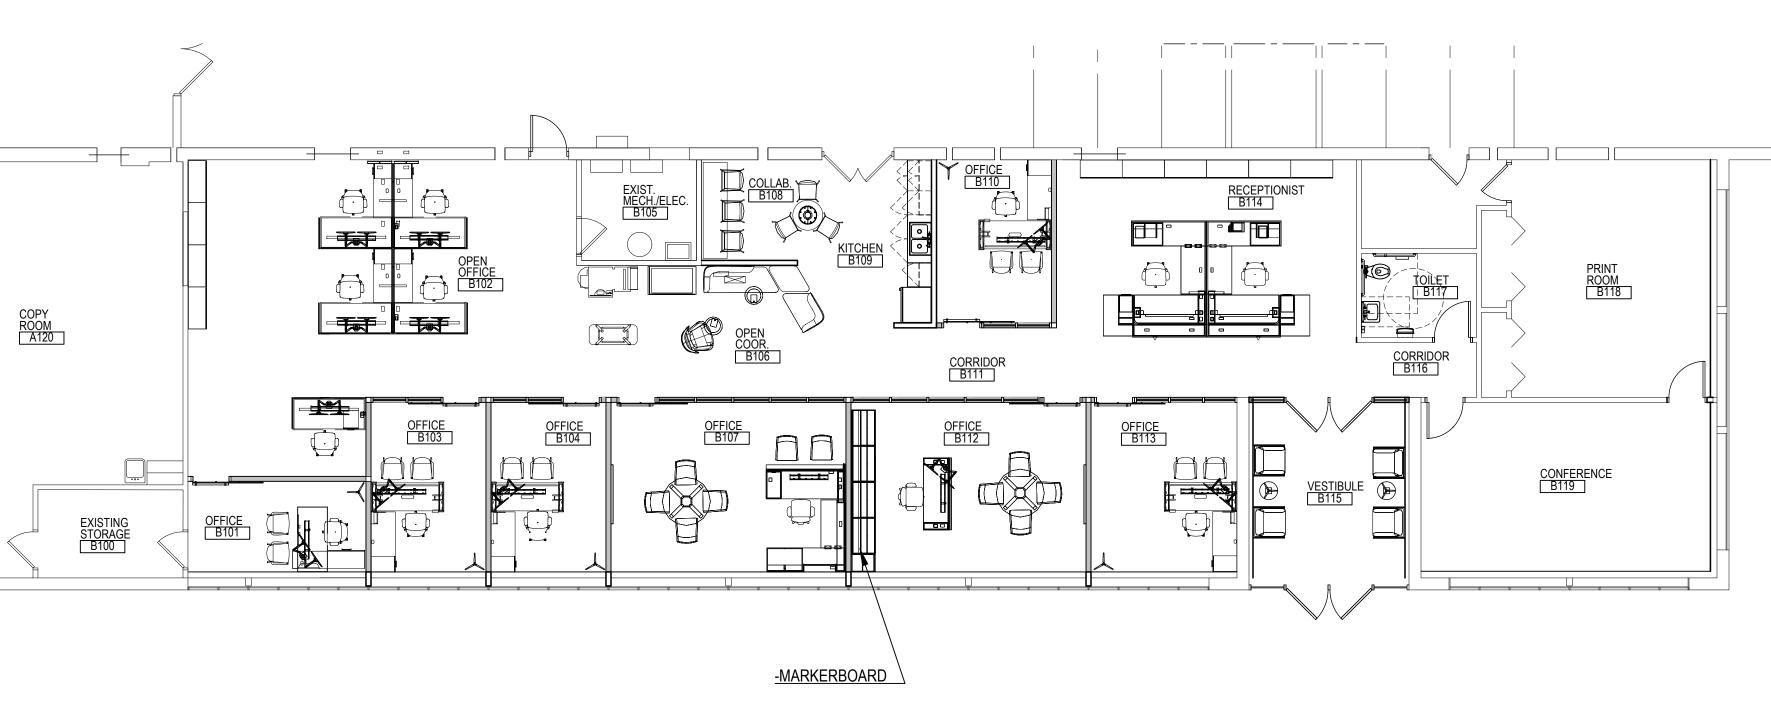
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RENOVA-

^{JOB NO}.242053



PRINT ROOM B118

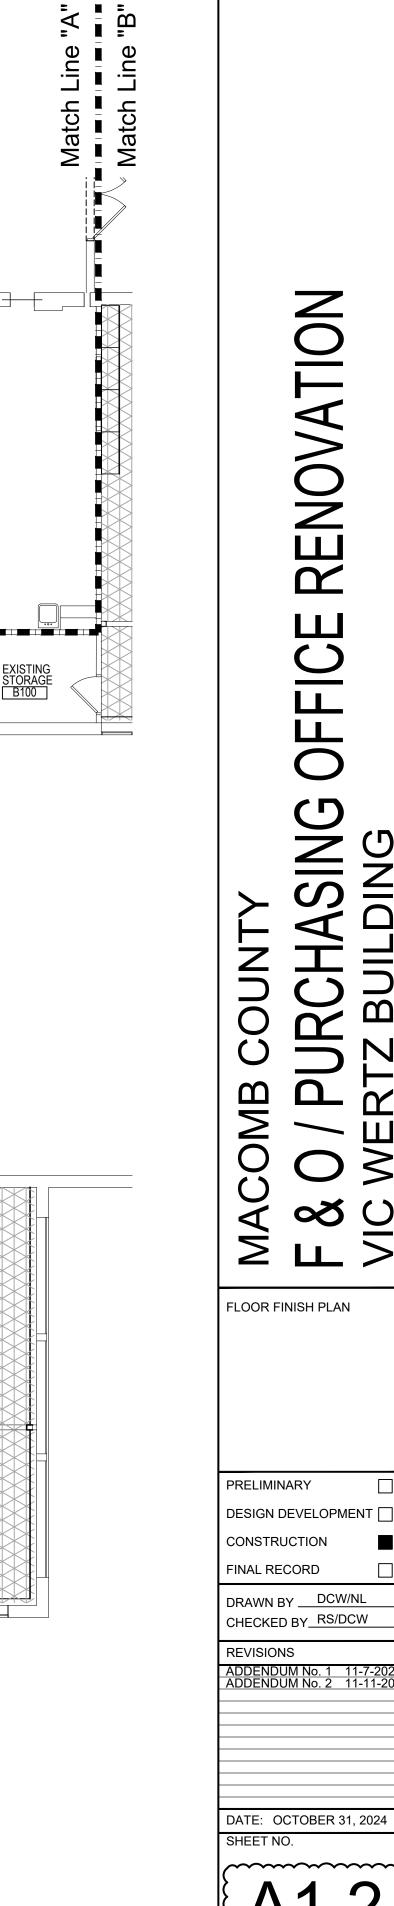





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MACOMB COUNTY

F & O / PURCHASING OFFICE RENOVATIC

VIC WERTZ BUILDING

FURNITURE PLAN LAYOUT

PRELIMINARY

DESIGN DEVELOPMENT

CONSTRUCTION

FINAL RECORD

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DATE: OCTOBER 31, 2024
SHEET NO.

A 1.3

NEW WORK KEYNOTES:

30500 VAN DYKE AVENUE

RENOVA-URCHASING TZ BUILDING

REFLECTED CEILING PLAN

PRELIMINARY DESIGN DEVELOPMENT CONSTRUCTION FINAL RECORD

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OFFICE RENOVATION

EXTERIOR ELEVATIONS

PRELIMINARY
DESIGN DEVELOPMENT
CONSTRUCTION
FINAL RECORD

CONSTRUCTION

FINAL RECORD

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REVISIONS

REVISIONS

ADDENDUM No. 1 11-7ADDENDUM No. 2 11-11

DATE: OCTOBER 31, 2024
SHEET NO.


A3.0

JOB NO.
242053

PARTIAL DEMOLITION


EAST ELEVATION (F&O)

A3.0 SCALE: 1/8" = 1'-0"

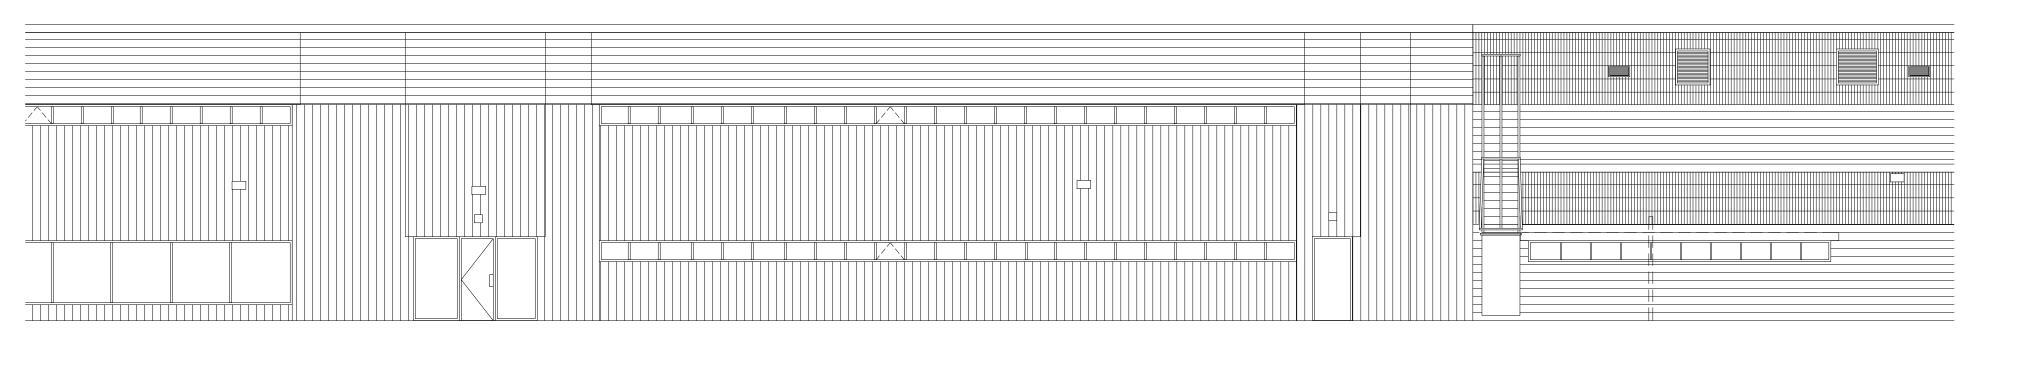


PARTIAL EAST ELEVATION
(PURCHASING)

A3.0 SCALE: 1/8" = 1'-0"

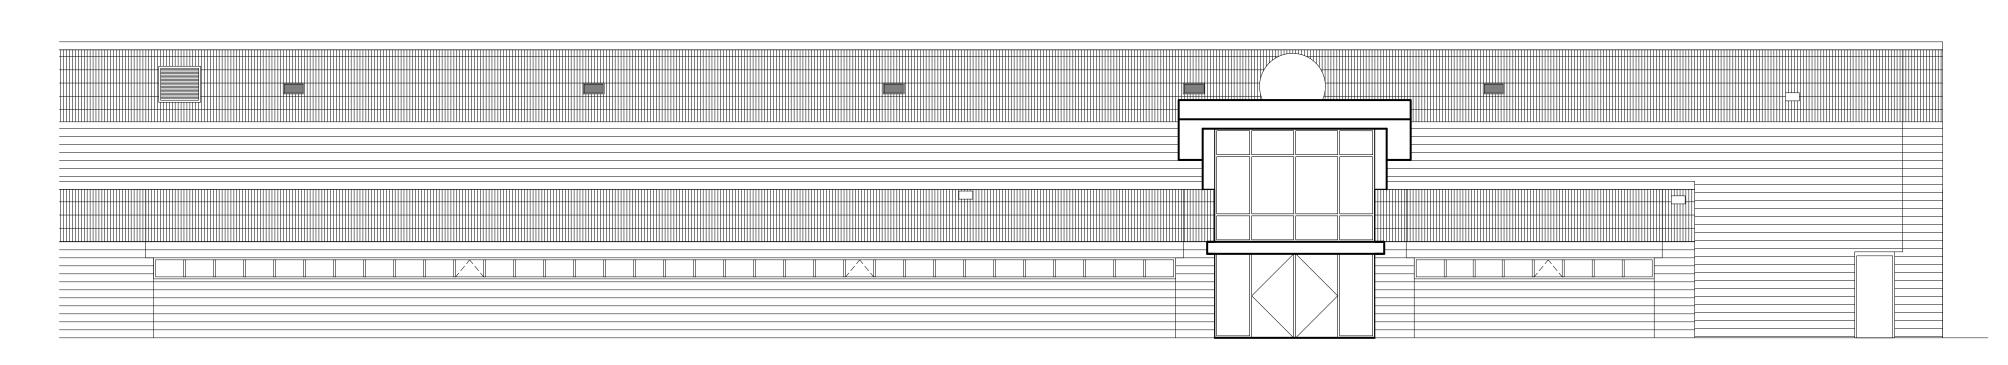

PARTIAL EAST ELEVATION
(F&O)

SCALE: 1/8" = 1'-0"

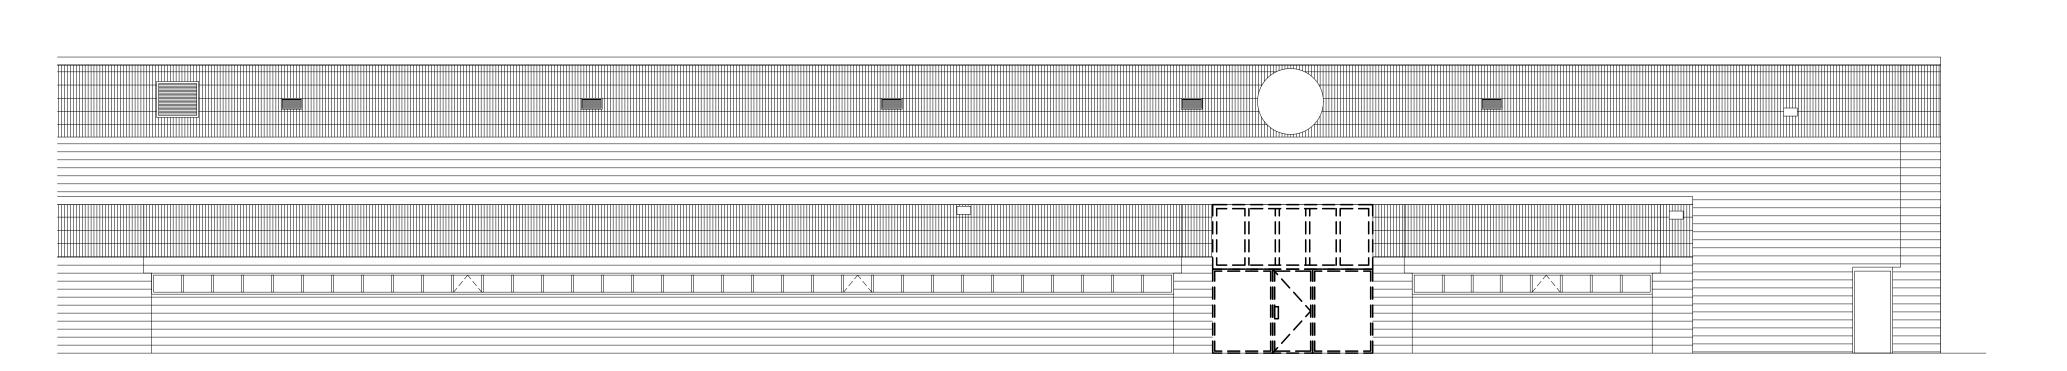



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ADDENDUM No. 1 11-7-2024
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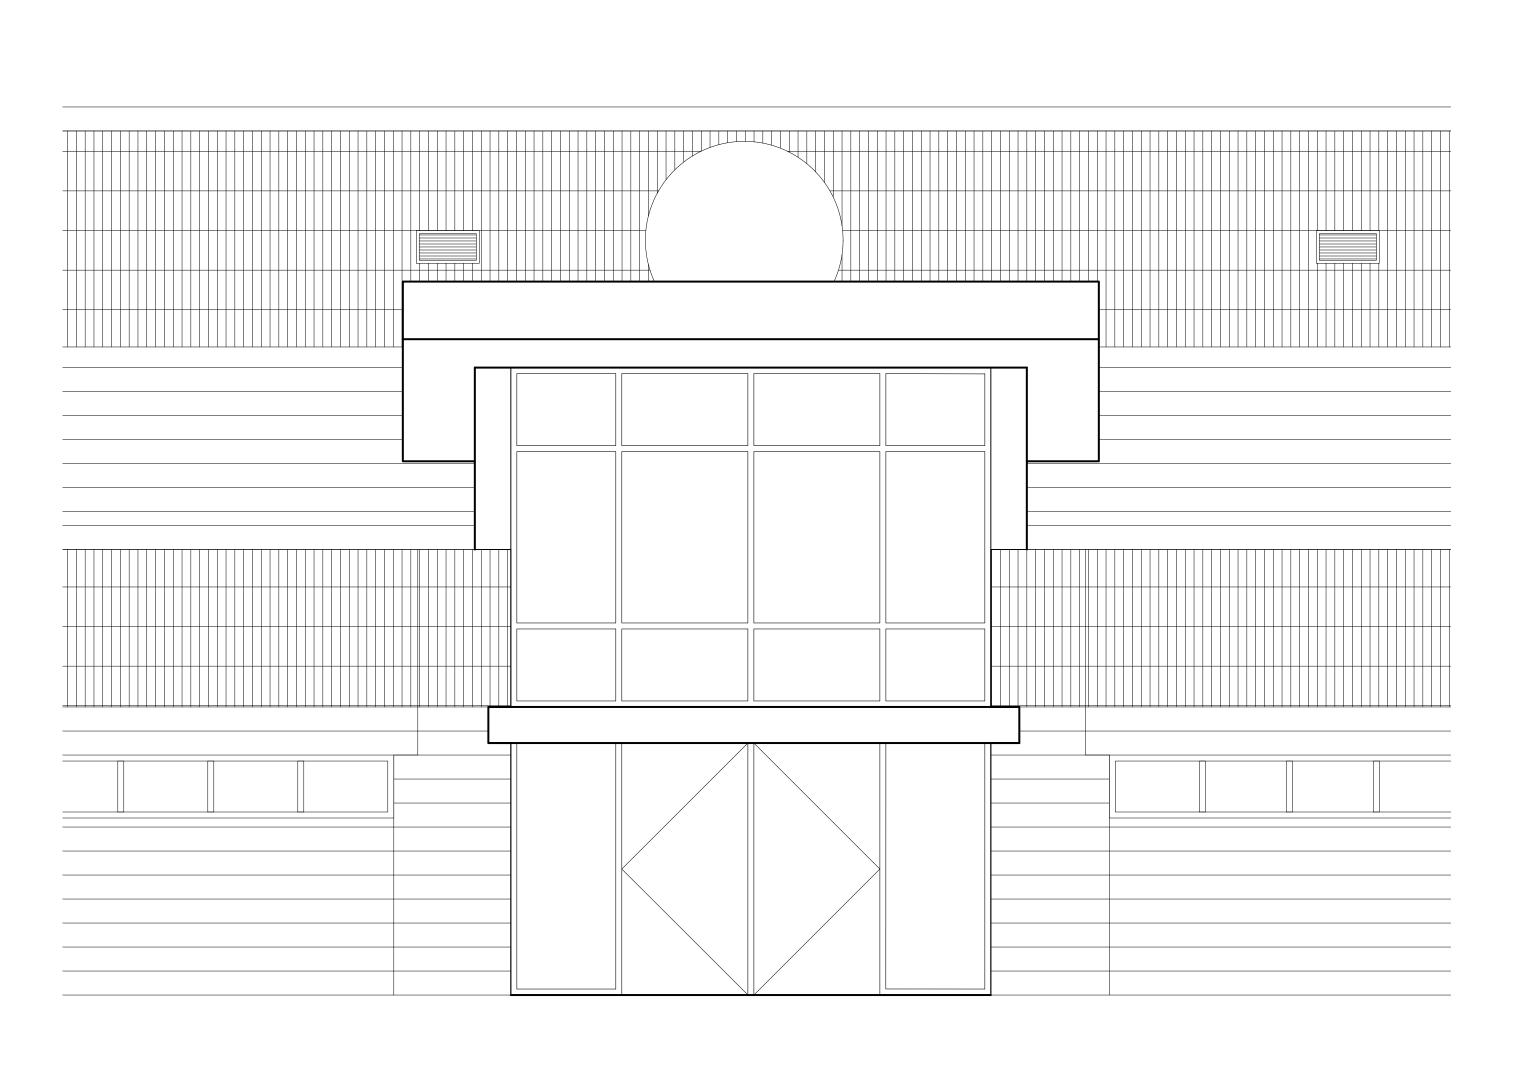
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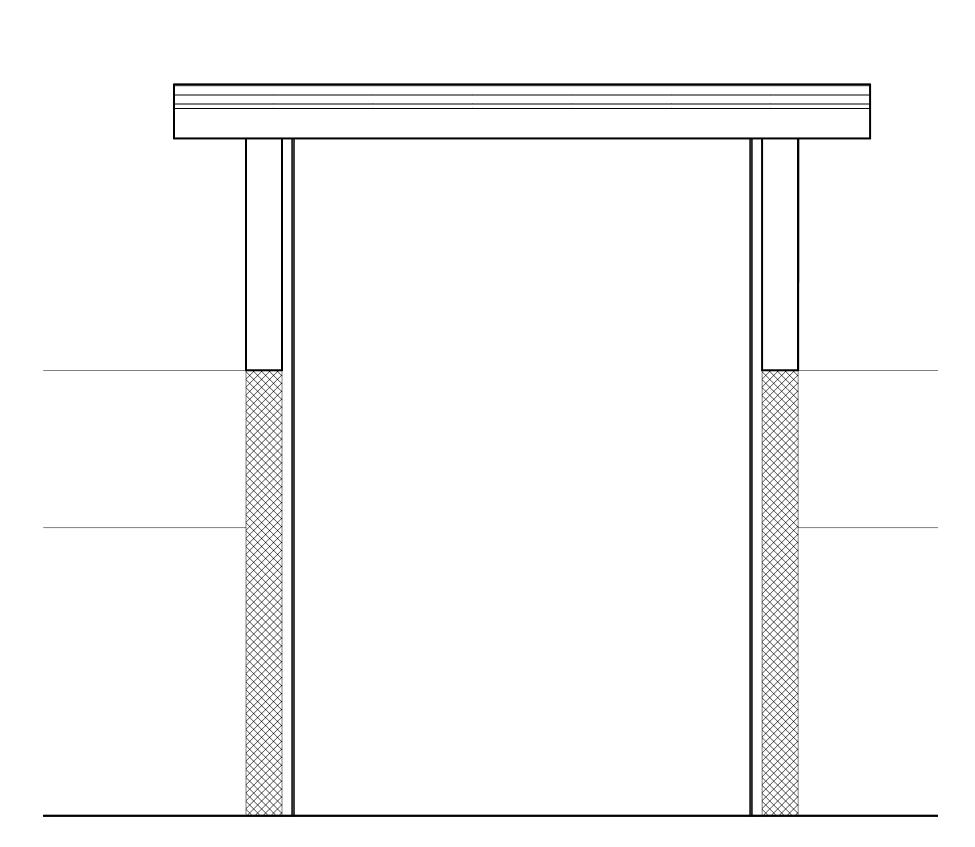








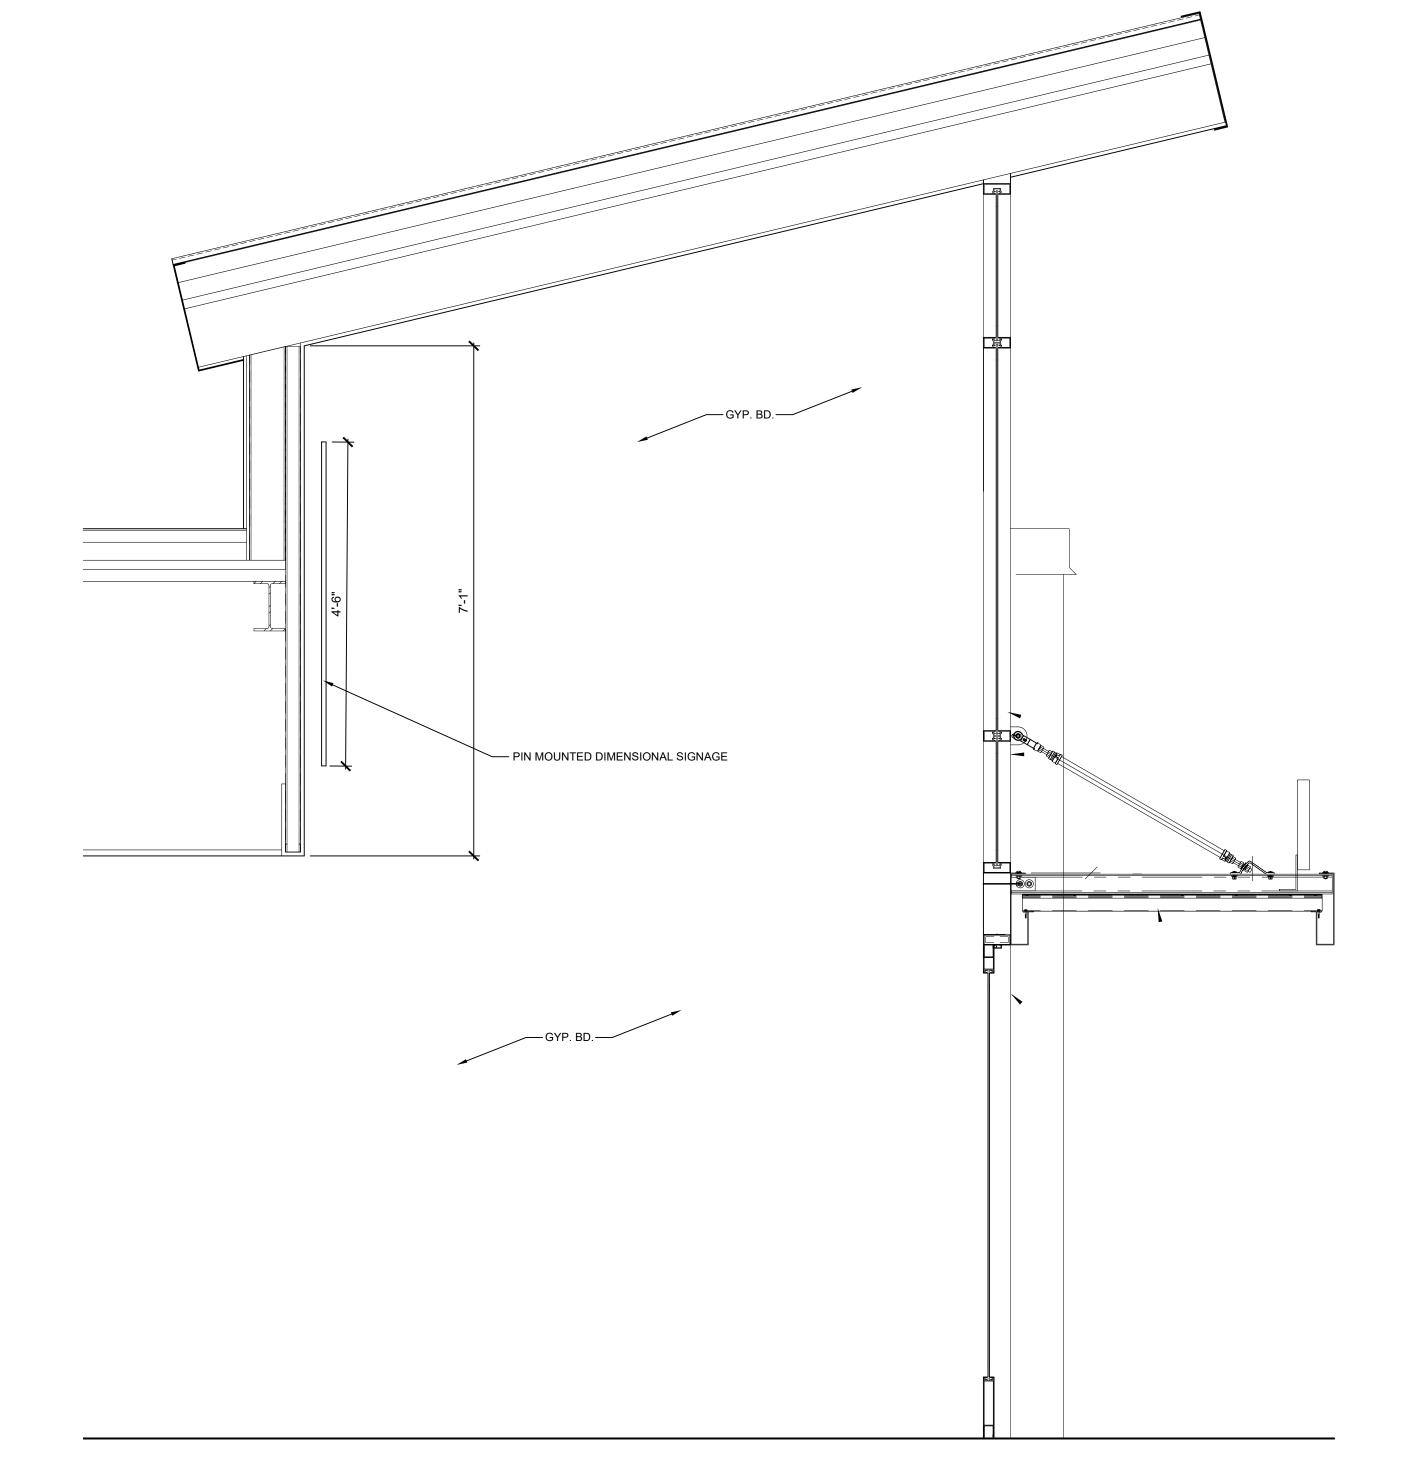

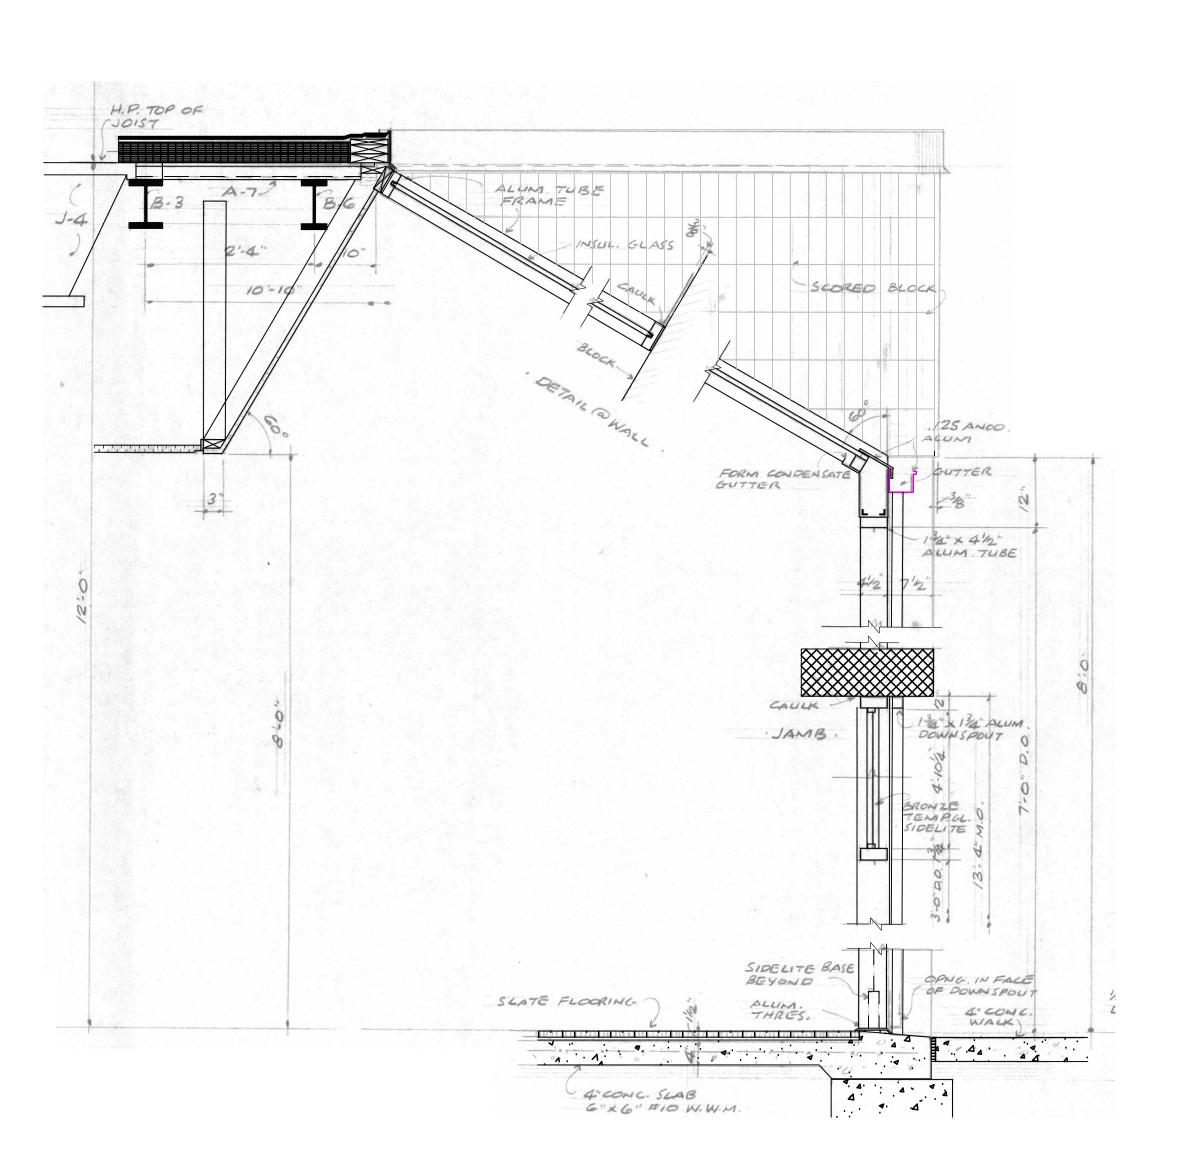

NEW WORK ELEVATION @ P&O ENTRANCE

A4.0 SCALE: 3/8" = 1'-0"





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MACOMB COUNTY

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VIC WERTZ BUILDING

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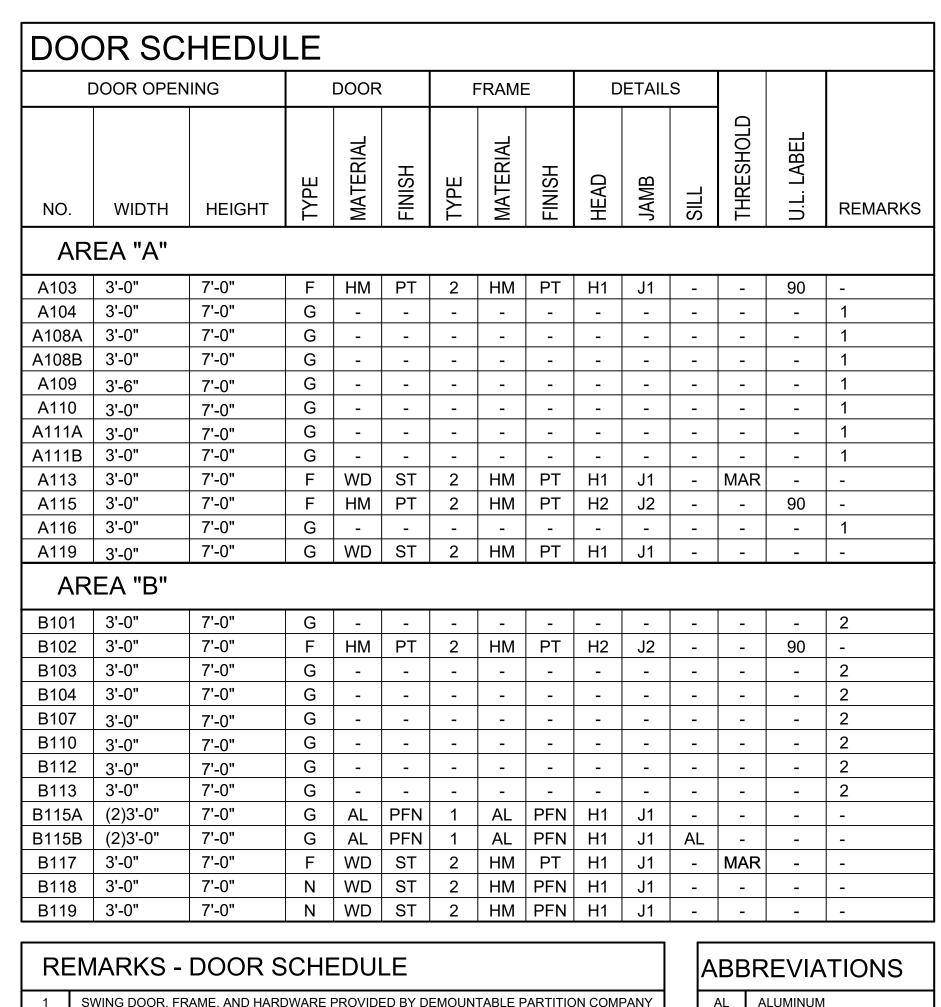
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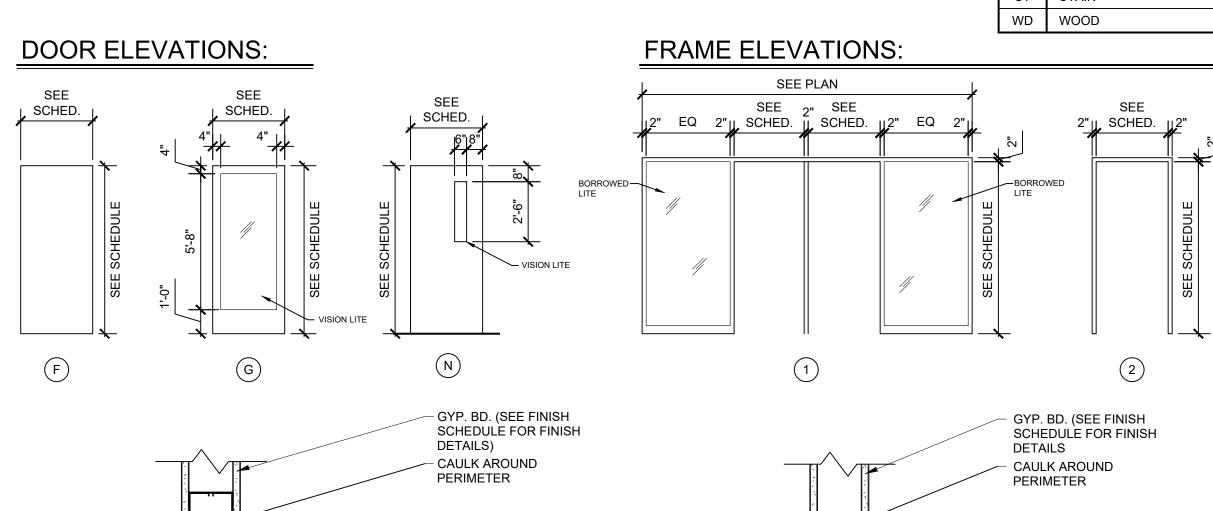
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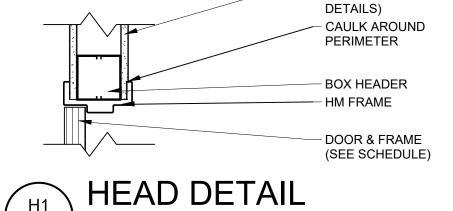
A4.1


JOB NO. 242053





RE	EMARKS - DOOR SCHEDULE	ABE	BREVIATION
1	SWING DOOR, FRAME, AND HARDWARE PROVIDED BY DEMOUNTABLE PARTITION COMPANY	AL	ALUMINUM
2	SLIDING DOOR, FRAME, AND HARDWARE PROVIDED BY DEMOUNTABLE PARTITION COMPANY	НМ	HOLLOW METAL
3	-	PFN	PRE-FINISHED
		PT	PAINT
		MAR	MARBLE
		ST	STAIN







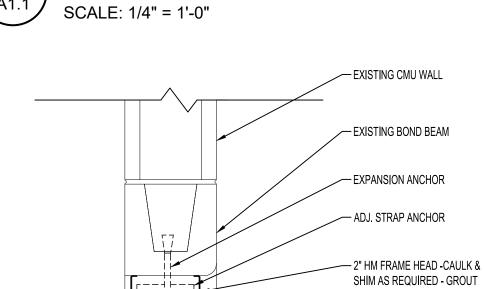

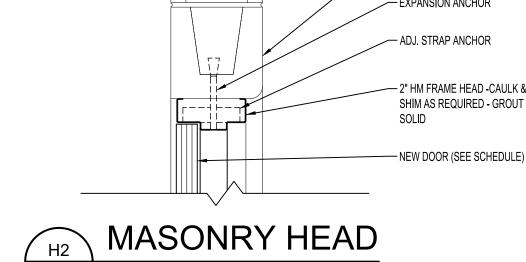

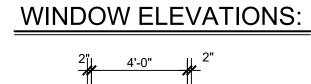

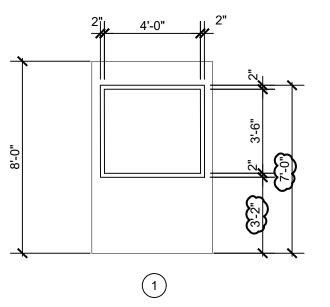

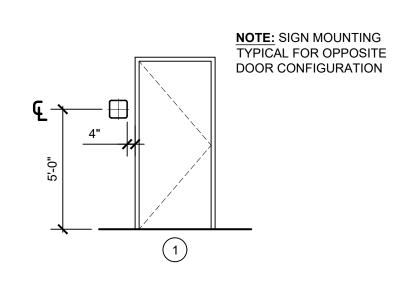

METAL FRAMING

DOOR & FRAME (SEE SCHEDULE)

--- EXPANSION ANCHOR

— ADJ. STRAP ANCHOR

__2" HM FRAME HEAD -CAULK & SHIM AS REQUIRED - GROUT

- NEW DOOR (SEE SCHEDULE)

HM FRAME

JAMB DETAIL

MASONRY JAMB

SCALE: 1 1/2" = 1'-0"

SCALE: 1 1/2" = 1'-0"




				WALLS			CEILING			
NO.	ROOM NAME	FLOOR	BASE	NORTH	SOUTH	WEST	EAST	MAT'L	HGT.	REMARKS
Α	REA "A" - PURCI	HASING								
A100	EXISTING STAIR	ETR	ETR	ETR	ETR	ETR	ETR	ETR	ETR	-
A101	CORRIDOR	ETR	ETR	ETR	ETR	ETR	ETR	ETR	ETR	-
A102	EXIST. STORAGE	ETR	ETR	ETR	ETR	ETR	ETR	ETR	ETR	-
A103	VESTIBULE	WOC	СТ	PT	PT	PT	PT	ACT	9'-0"	1,3,4
A104	TECH.	LVT	RB	PT	PT	PT	PT	ETR	ETR	1,3,4,5
A105	CORRIDOR	LVT	RB	PT	PT	PT	PT	ACT	8'-0"	1,3,4,5
A106	WAITING	LVT	RB	PT	PT	PT	PT	ACT	8'-0"	1,4,5
A107	RECEPTION	CPT	RB	PT	DP	GL,PT	DP	ACT	9'-0"	1,2,4,5
A108	OFFICE	CPT	RB	PT	PT	PT	DP	ACT	9'-0"	1,2,3,4,5
A109	RECEPTION	CPT	RB	PT	PT	DP	PT	ACT	9'-0"	1,2,4,5
A110	OFFICE	CPT	RB	PT	PT	DP	PT	ACT	9'-0"	1,2,4,5
A111	CORRIDOR	LVT	RB	DP	DP	DP	DP	ACT	8'-0"	1,2,4,5
A112	COAT CLOSET	LVT	RB	PT	PT	PT	DP	ACT	8'-0"	1,2,4,5
A113	TOILET	CT	CT	СТ	СТ	СТ	СТ	ACT	8'-0"	1,3,4,5
A114	KITCHEN	LVT	RB	PT	PT	PT	DP	ACT	8'-0"	1,2,3,4,5
A115	OPEN OFFICE	CPT	RB	PT	PT	PT	DP	ACT	9'-0"	1,2,3,4,5
	OFFICE	CPT	RB	PT	PT	DP	PT	ACT	9'-0"	1,2,3,4,5
A117	EXISTING STAIR	ETR	ETR	ETR	ETR	ETR	ETR	ETR	ETR	1,2,0,1,0
	CORRIDOR	+		PT	DP					12215
A118		LVT	RB	PT	PT	DP	PT,DP DP	ACT	8'-0"	1,2,3,4,5
A119	OFFICE	CPT	RB			PT		ACT	9'-0"	1,2,3,4,5
A120	L	CPT	RB	ETR	ETR	ETR	ETR	ACT	ETR	
A	REA "B" - FACILI	IIIES AN	D OPER	AHON						
B100	EXISTING STORAGE	ETR	ETR	ETR	ETR	ETR	ETR	ETR	ETR	-
B101	OFFICE	CPT	RB	DP	PT	DP	PT	ACT	9'-0"	1,2,3,4,5
B102	OPEN OFFICE	CPT	RB	PT	PT	PT	DP	LW	8'-8"	2,3,4,5
B103	OFFICE	CPT	RB	DP	DP	DP	PT	ACT	9'-0"	2,3,4,5
B104	OFFICE	CPT	RB	DP	DP	DP	PT	ACT	9'-0"	2,3,4,5
B105	EXIST. MECH./ELEC.	ETR	ETR	ETR	ETR	ETR	ETR	ETR	ETR	-
B106	OPEN CORRIDOR	LVT	RB	PT	PT	PT	DP	ES	ETR	1,3,4,5,6
B107	OFFICE	CPT	RB	DP	DP	DP	PT	ACT	9'-0"	2,3,4,5
B108	COLLABORATION	CPT	RB	PT	PT	PT	PT	ES/PT	ETR	1,3,4,5
B109	KITCHEN	LVT	RB	PT	PT	PT	PT	ES/PT	ETR	1,3,4,5
	OFFICE	CPT	RB	DP	PT	PT	DP	ACT	9'-0"	1,2,3,4,5
B110	CORRIDOR	LVT	RB	PT	PT	DP	DP	ES/PT	ETR	1,3,4,5,6
B110 B111			RB	DP	DP	DP	PT	ACT	9'-0"	1,2,3,4,5
	OFFICE	CPT			į.				+	+ ' ' '
B111 B112	OFFICE OFFICE	CPT	RB	PT	DP	DP	PT	ACT	9'-0"	1.2.3.4.5
B111 B112 B113				PT PT			PT PT			1,2,3,4,5 2,3,4,5
B111 B112 B113 B114	OFFICE	СРТ	RB	PT	DP	PT		LW	8'-8"	2,3,4,5
B111 B112 B113 B114 B115	OFFICE RECEPTIONIST VESTIBULE	CPT CPT CT	RB RB CT	PT ETR	DP ETR	PT PT/GL	PT GL	LW ES/PT		2,3,4,5 1,3,4,6
B111 B112 B113 B114 B115 B116	OFFICE RECEPTIONIST VESTIBULE CORRIDOR	CPT CPT CT LVT	RB RB CT RB	PT ETR PT	DP ETR PT	PT PT/GL PT	PT GL PT/GL	LW ES/PT ES/PT	8'-8" ETR	2,3,4,5 1,3,4,6 1,3,4,6
B111 B112 B113 B114 B115 B116 B117	OFFICE RECEPTIONIST VESTIBULE	CPT CPT CT	RB RB CT	PT ETR	DP ETR	PT PT/GL	PT GL	LW ES/PT	8'-8"	2,3,4,5 1,3,4,6

	SIC	IGNAGE SCHEDULE							
QTY PLAN NO. TYPE MOUNTING TEXT									
	AREA "A" - PURCHASING								
ĺ	1 A100 A 1 LINE 1: STAIR								
1 A113 A 1 LINE 1					LINE 1: UNISEX				
	1 A117 A 1 LINE 1: STAIR								
	AREA "B" - FACILITIES AND OPERATION								
	1 B117 A 1 LINE 1: UNISEX								

REMARKS - ROOM SCHEDULE							
1	ALL GYPSUM BOARD TO BE 5/8" HIGH ABUSE BOARD UNLESS OTHERWISE NOTED.						
2	DEMOUNTABLE PARTITION COMPANY TO PROVIDE CEILING CLIPS TO ANCHOR NEW CEILINGS TO NEW DEMOUNTABLE PARTITIONS						
3	PATCH AND REPAINT ALL EXISTING WALLS REQUIRED.						
4	PROVIDE AND INSTALL ALL REQUIRED FLOOR TRANSITIONS, PIECES, AND THRESHOLDS						
5	ALL DEMOUNTABLE PARTITIONS DO NOT HAVE RUBBER BASE INSTALLED. RUBBER BASE IS ONLY ON CONSTRUCTION WALLS						
6	IN ALL OPEN AREAS, PAINT ALL EXPOSED DECK, STRUCTURE, DUCTWORK, CONDUIT, ETC. COMPLETE FOR A FINISHED PRODUCT						

ABBREVIATIONS							
ACT	ACOUSTICAL CEILING TILE AND GRID	PT	PAINT				
CMU	CONCRETE MASONRY UNITS	GL	GLASS				
СТ	CERAMIC TILE	DP	DEMOUNTABLE PARTITION				
ETR	EXISTING TO REMAIN	LW	LINEAL WOOD				
EP	EPOXY PAINT	ES	EXPOSED STRUCTURE				
GB	GYPSUM BOARD	WOC	WALK-OFF CARPET				

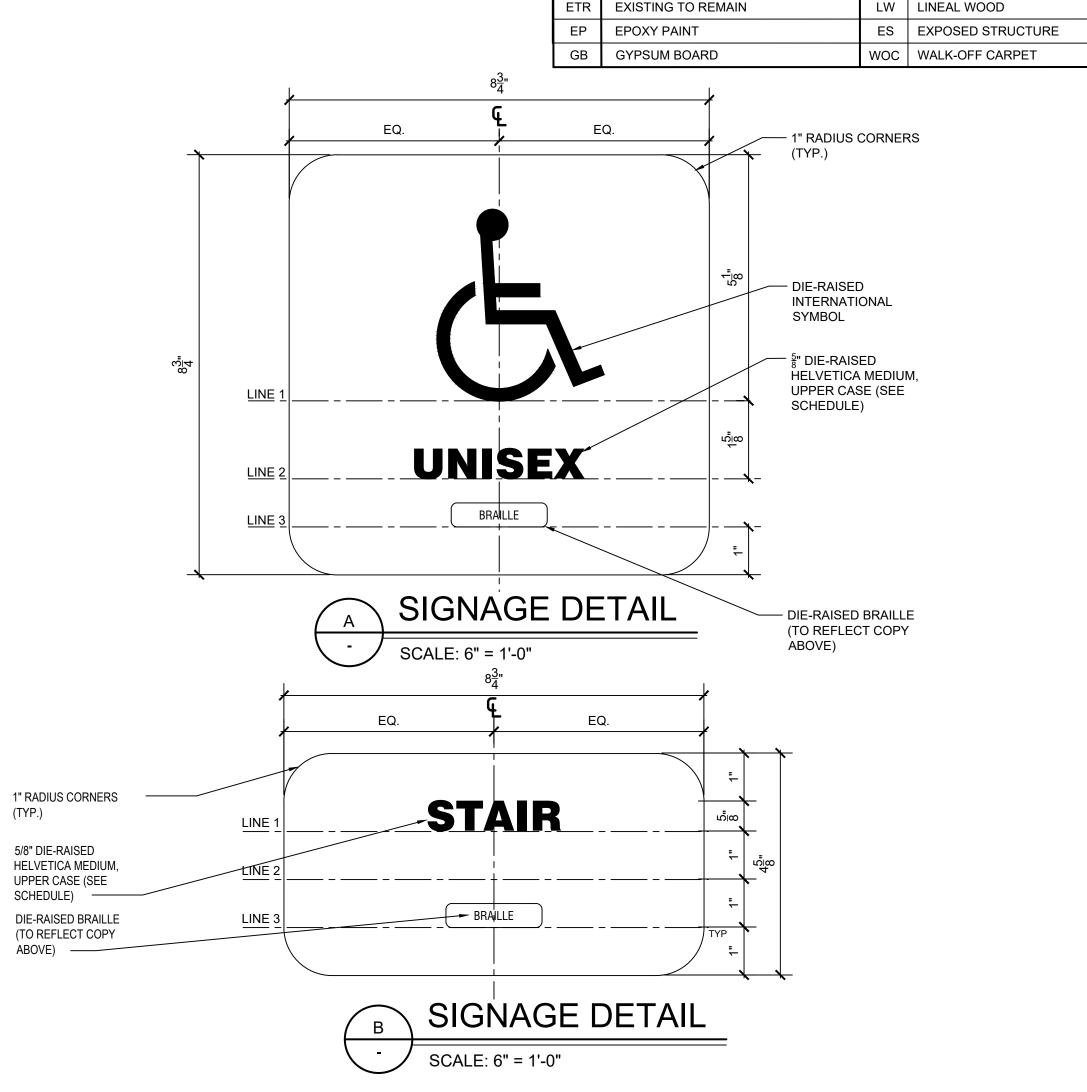



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RENOVA: OFFICE MACOMB F & 0 / PI VIC WERT DOOR, FINISH, AND SIGNAGE SCHEDULES

PRELIMINARY

DESIGN DEVELOPMENT ☐ CONSTRUCTION FINAL RECORD DRAWN BY ___DCW/NL

CHECKED BY RS/DCW REVISIONS ADDENDUM No. 1 11-7-2024 ADDENDUM No. 2 11-11-202

DATE: OCTOBER 31, 2024